DEVELOPMENT SERVICES DIRECTOR PUBLIC HEARING

AGENDA ITEM 1

REQUEST

PUBLIC HEARING TO CONSIDER A DEVELOPMENT REVIEW PERMIT APPLICATION FOR ADDITIONAL PARKING AT 6551 WEST SCHULTE ROAD, ASSESSOR'S PARCEL NUMBER 209-120-09. APPLICANT IS HPA, INC. AND PROPERTY OWNER IS PROLOGIS, L.P. – APPLICATION NUMBER D22-0049

DISCUSSION

Project Background and Description

On September 8, 2016, the Development Services Director approved a development review permit for an approximately 324,000 sq ft light industrial building in the Cordes Ranch Specific Plan Area, also known as IPC Building 3 (D16-0011), at 6551 W. Schulte Rd. The project was constructed in 2017 and has since been occupied by industrial uses. According to the applicant, the property owner had intended to add additional automobile parking areas in the future, but such parking was not included in the development review permit. Therefore, on December 29, 2022, the applicant submitted a development review permit application for 107 additional automobile parking spaces to be constructed. The expanded parking area will allow flexibility in use of the building, such as additional office areas supporting the light industrial uses.

The additional parking areas are proposed on two sides of the building in place of existing planters. The subject planter areas are in excess of the required onsite landscaping, where the northwestern planter is currently comprised by rock and the southeast planter is a large landscaping area that can accommodate a new parking area within the planter. The northwestern parking area will have 68 stalls and will be served by an existing drive aisle that currently runs along the building. The southeastern parking area will be comprised of 39 stalls and a new drive aisle that connects to existing drive aisles on the perimeter of the site. Landscaping, including canopy shade trees, will be provided for the additional parking areas with a palette that complements the existing landscaping. These proposed improvements are consistent with the Cordes Ranch Specific Plan and City standards for parking and landscaping.

Environmental Document

The Development Services Director has determined that the proposed project is consistent with the Cordes Ranch Specific Plan Environmental Impact Report (EIR), approved by the City Council on September 3, 2013, and the General Plan EIR approved by the City Council on February 1, 2011. Pursuant to CEQA Guidelines Section 15183, no additional environmental documentation is required. The project will not introduce significant on or off-site impacts which were not already discussed in the Cordes Ranch and General Plan EIRs. There is also no evidence of any significant impacts to occur off-site as a result of the project, as traffic, air quality, land use and other potential cumulative impacts have already been considered within the original

Development Services Director Public Hearing April 10, 2023 Page 2

environmental documentation. No new evidence of potentially significant effects has been identified as a result of this project.

RECOMMENDATION

Staff recommends that the Development Services Director approve the development review permit for additional parking at 6551 W. Schulte Rd., based on the findings contained in the Director's Determination dated April 10, 2023 (Attachment B).

Prepared by: Kimberly Matlock, Associate Planner

Reviewed by: Alan Bell, Senior Planner

Approved by: Bill Dean, Assistant Development Services Director

<u>ATTACHMENTS</u>


Attachment A – Proposed Development Plans dated December 29, 2022


Attachment B – Development Services Director Determination

Exhibit 1 – Conditions of Approval



RECEIVED December 29, 2022 City of Tracy Development Services International Park of Commerce Bldg. 3 Tracy, CA

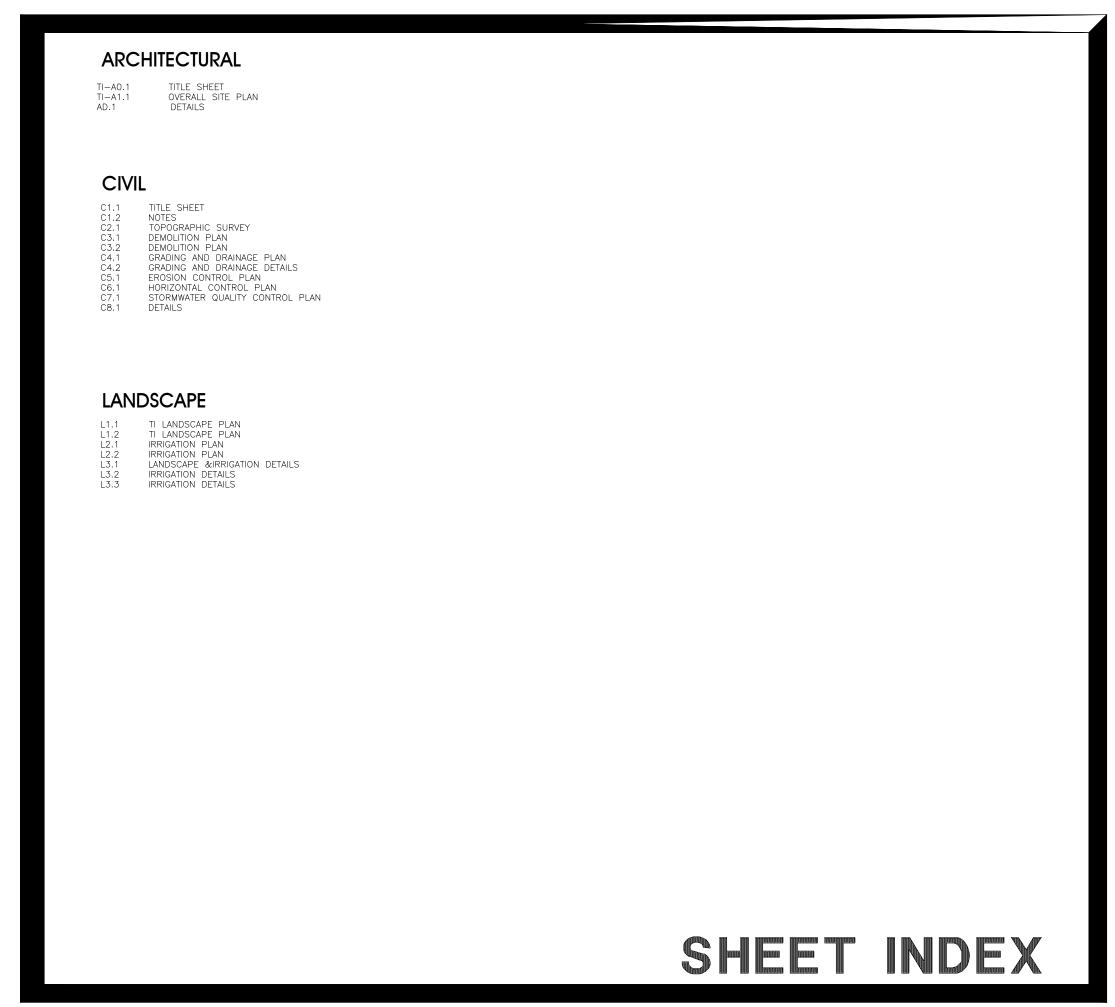

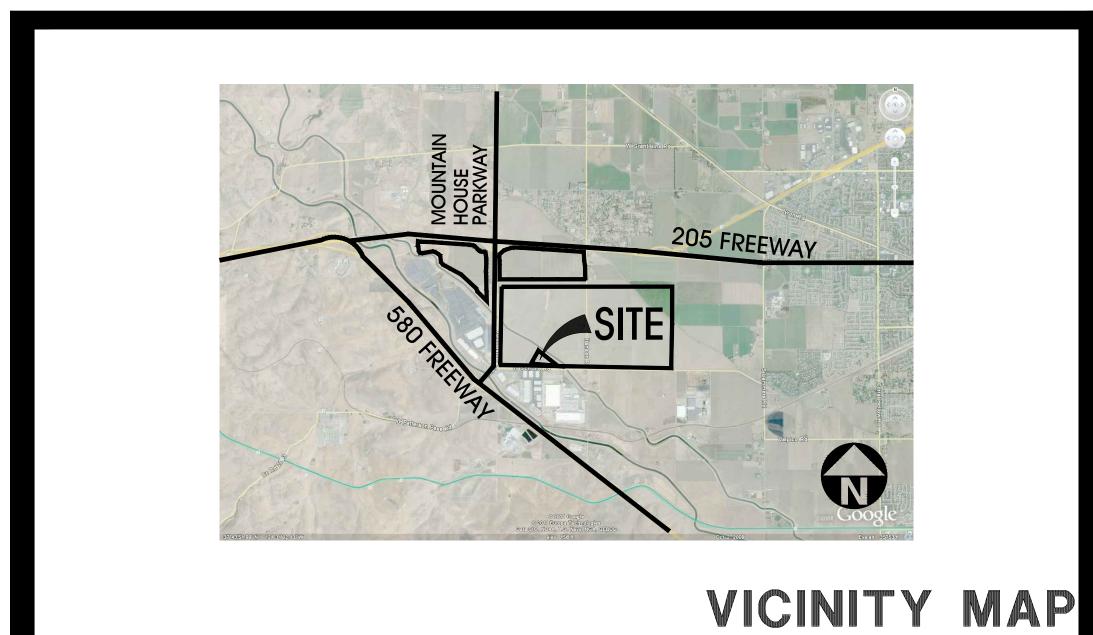


SCOPE OF WORK

ADD NEW AUTO PARKING AT AREAS PREVIOUSLY PLANNED FOR FUTURE PARKING

OWNER: **PROLOGIS** 3353 GATEWAY BLVD. FREMONT, CA 94538-6526 PHONE: +1 (209) 833-5395 CONTACT: CLAIRE WILSON ARCHITECT: 18831 BARDEEN AVE., SUITE 100 IRVINE, CA 92612 PHONE: (949) 863-1770 FAX: (949) 863-0851 CONTACT: TERESA GOODWIN

PROJECT REPRESENTATIVES

BUILDING & PLANNING DEPT.	CODE	PROJECT DATA:	
TRACY BUILDING DIVISION	CBC 2019 CPC 2019	<u>TOTAL</u>	
333 CIVIC CENTER DR. TRACY, CA 95376	CMC 2019 CEC 2019	SITE AREA	
TRACT, CA 70070	CFC 2019	in s.f. 817,095 s.f.	
	ENERGY STANDARDS 2019	in acres 18.8 ac	
	2019 CALGREEN	BUILDING AREA office 11,009 s.f.	
OWNER / APPLICANT		warehouse 312,979 s.f. TOTAL 323,988 s.f.	
PROLOGIS		,	
3353 GATEWAY BLVD.		COVERAGE (50% Max.) AUTO PARKING REQURIED	
FREMONT, CA 94538-6526 PHONE: +1 (209) 833-5395		office @ 1/250 s.f. 44 stalls	
CONTACT: CLAIRE WILSON		warehouse 1st 20K @ 1/1,000 s.f. 20 stalls	
		2nd 20K @ 1/2,000 s.f. 10 stalls	
		above 40K @ 1/4,000 s.f. 69 stalls	
		TOTAL 143 stalls	
		AUTO PARKING PROVIDED	
LAND USE/ZONING:		Existing standard (9'x20') 145 stalls	
		New standard (9'x20') 107 stalls	
BPI (BUSINESS PARK INDUSTRIAL)		TOTAL 252 stalls	
		TRAILER PARKING PROVIDED	
		trailer (10'x53') 73 stalls	
AREA JUSTIFICATION:		MAXIMUM FLOOR AREA RATIO	
60' SIDE YARDS ALL SIDES		F.A.R50	
FULLY SPRINKLERED- UNLIMITED AREA		ZONING ORDINANCE FOR THE CITY	
		Zoning Designation - Cordes Ranch Specific Plan	
DIJUDING ADDDECC.		- Business Park Industrial (BPI)	
BUILDING ADDRESS: 6551 WEST SCHULTE ROAD, SUITE 100		<u>SETBACKS</u>	
TRACY, CA		<u>Building</u>	
		front / Street - 30'	
ACCECCODIC DADOEL NO		side & rear (non street) - 10'	
ASSESSOR'S PARCEL NO.:		<u>Landscape</u>	
209-120-030-000 209-120-040-000		Old Schulte Road - 30'	
209-120-060-000 209-120-050-000 209-120-070-000			
209-120-070-000			
	TA & CODE SUN		

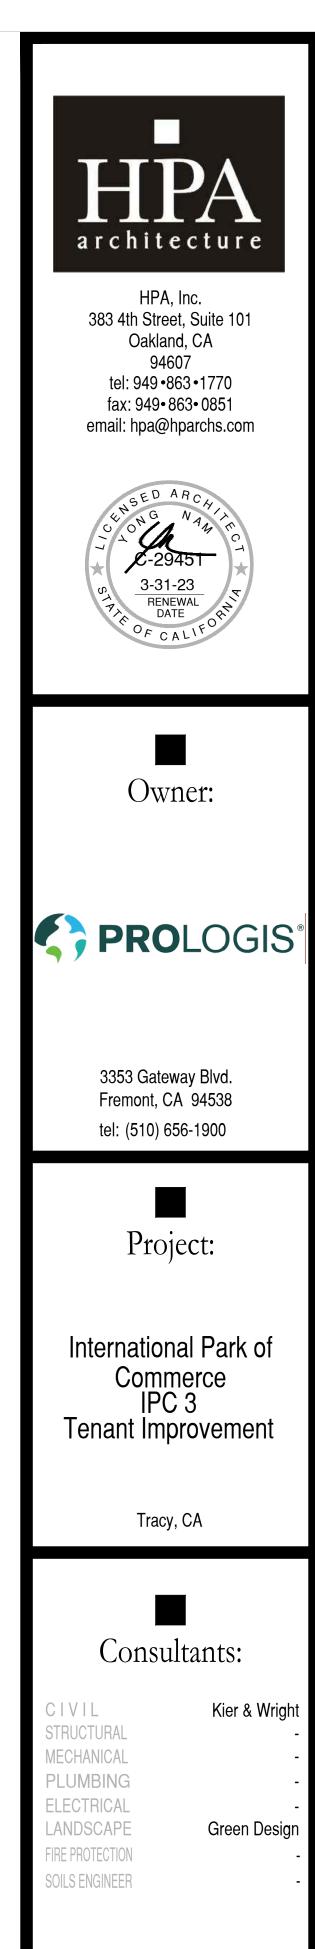

TITLE SHEET


Project Number:

Drawn by:

Revision:

Date:

22608

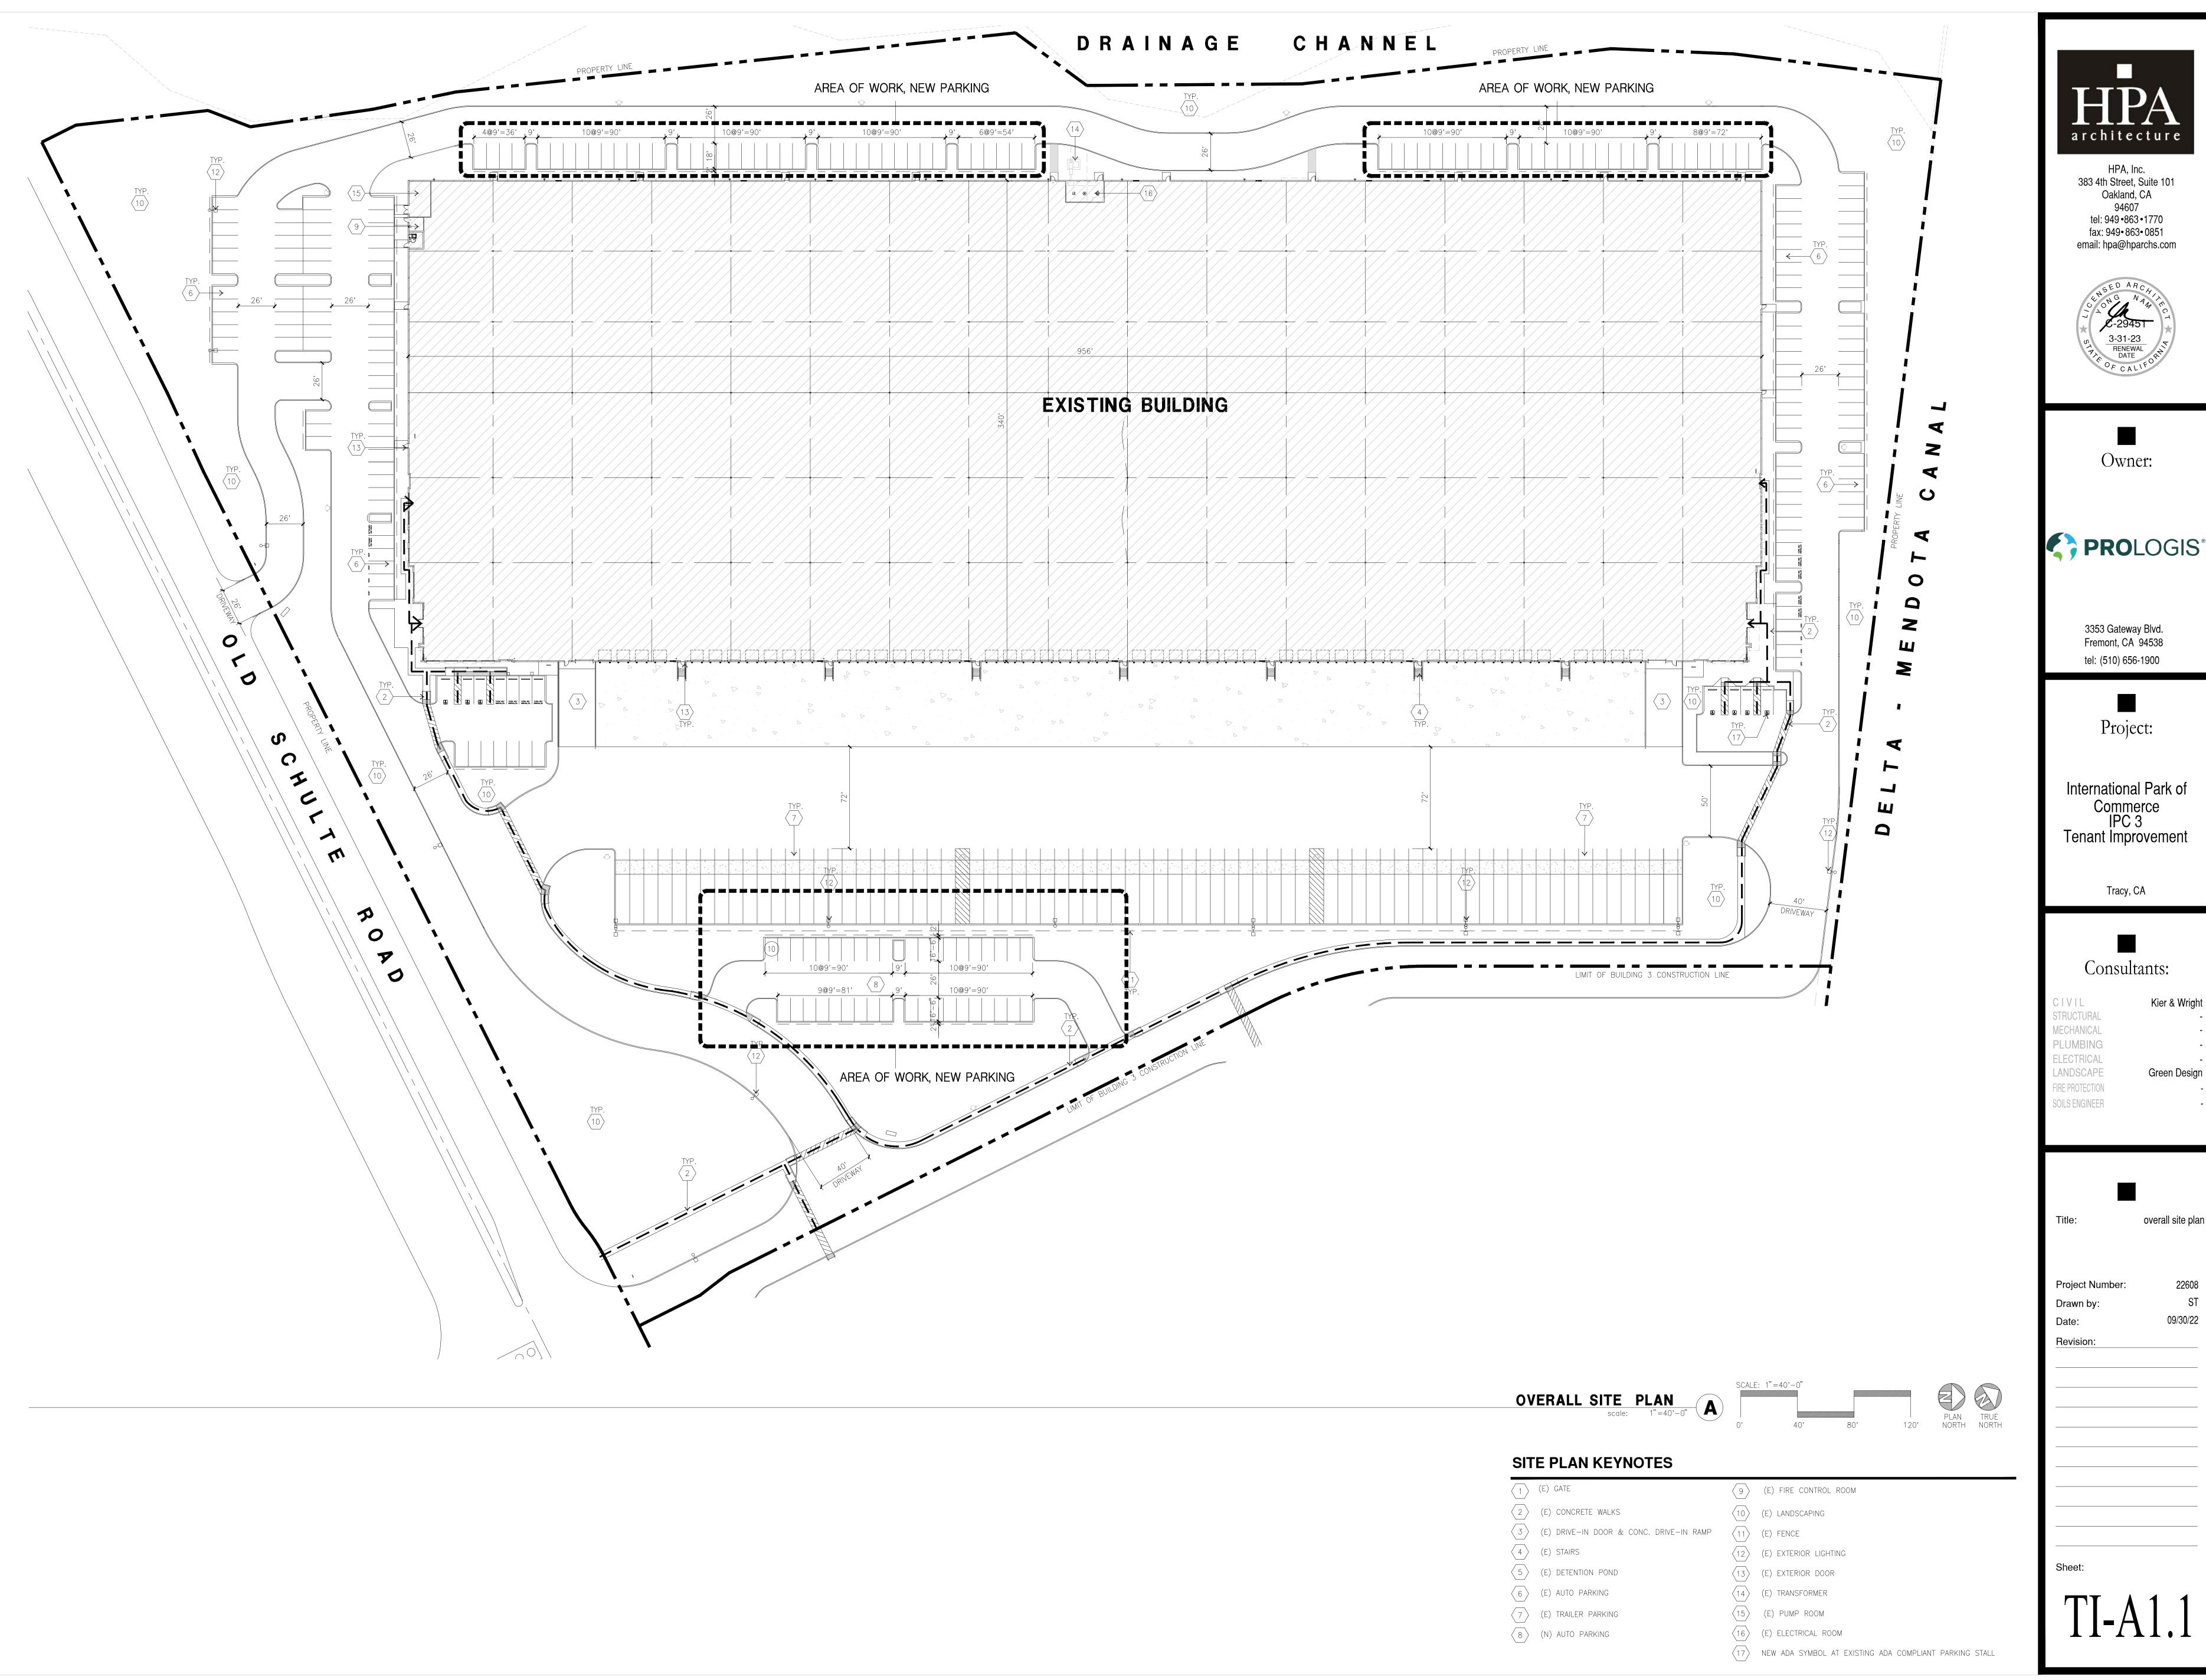

architecture







Commerce IPC 3 Tenant Improvement

Green Design

overall site plan

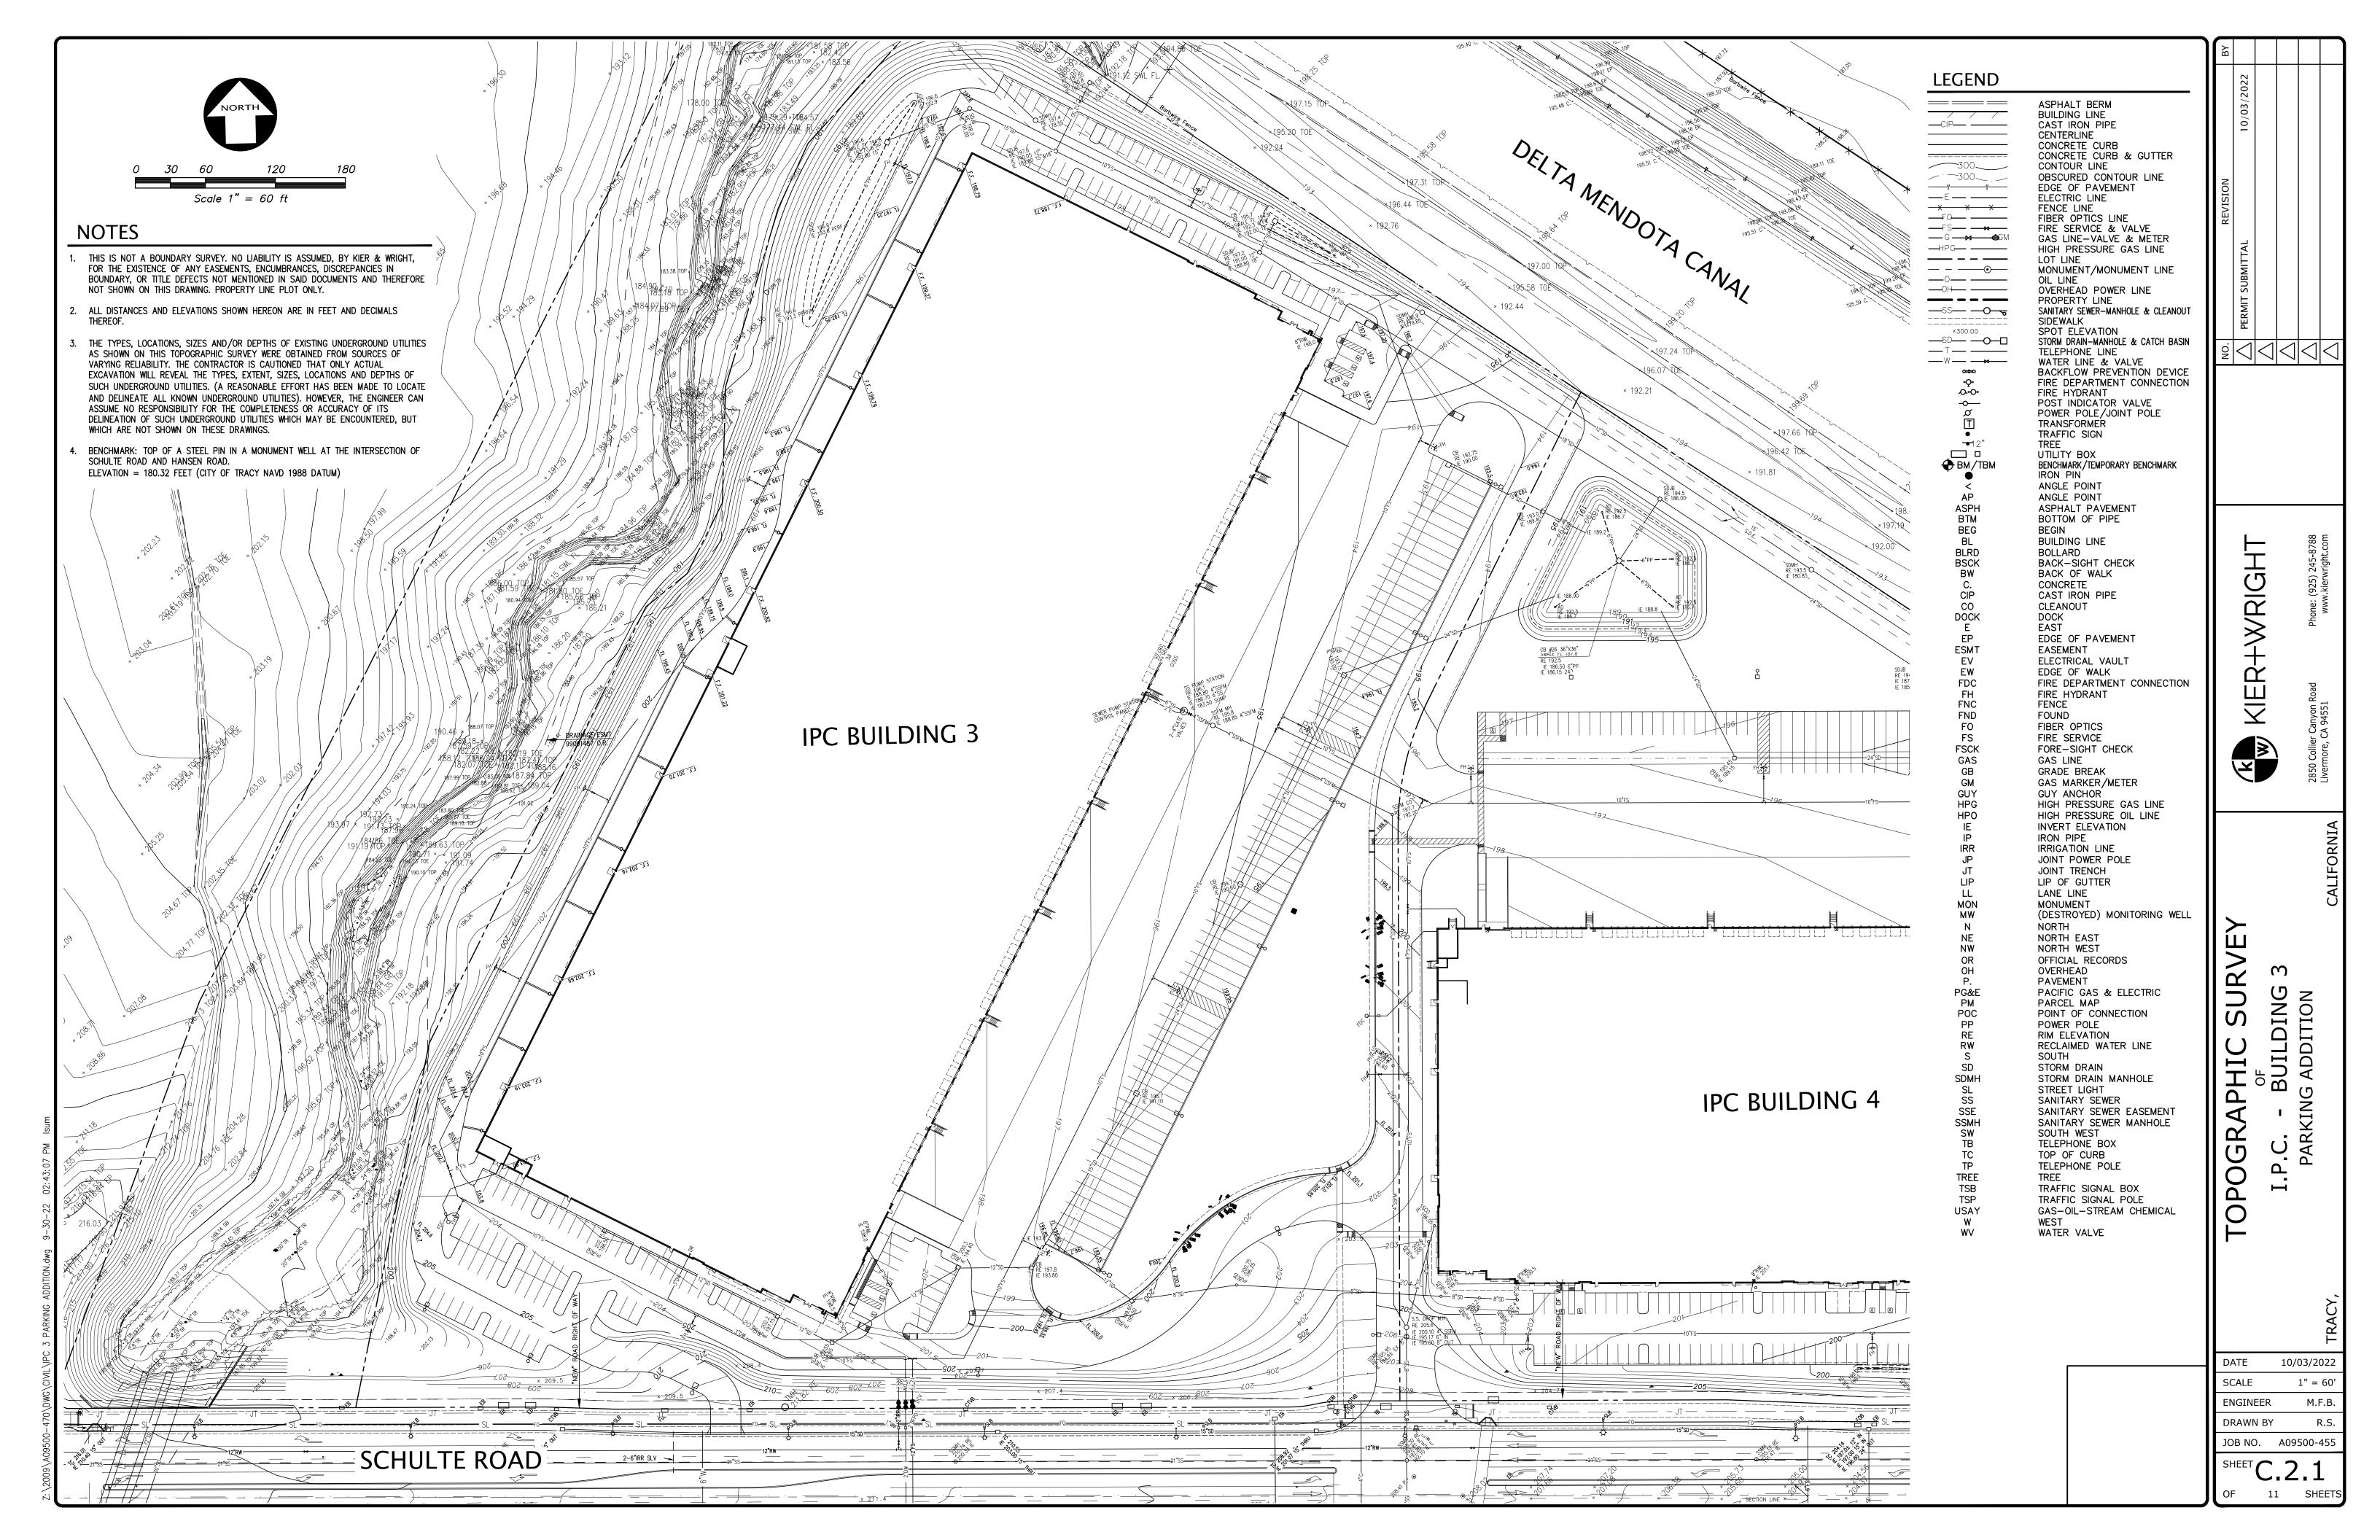

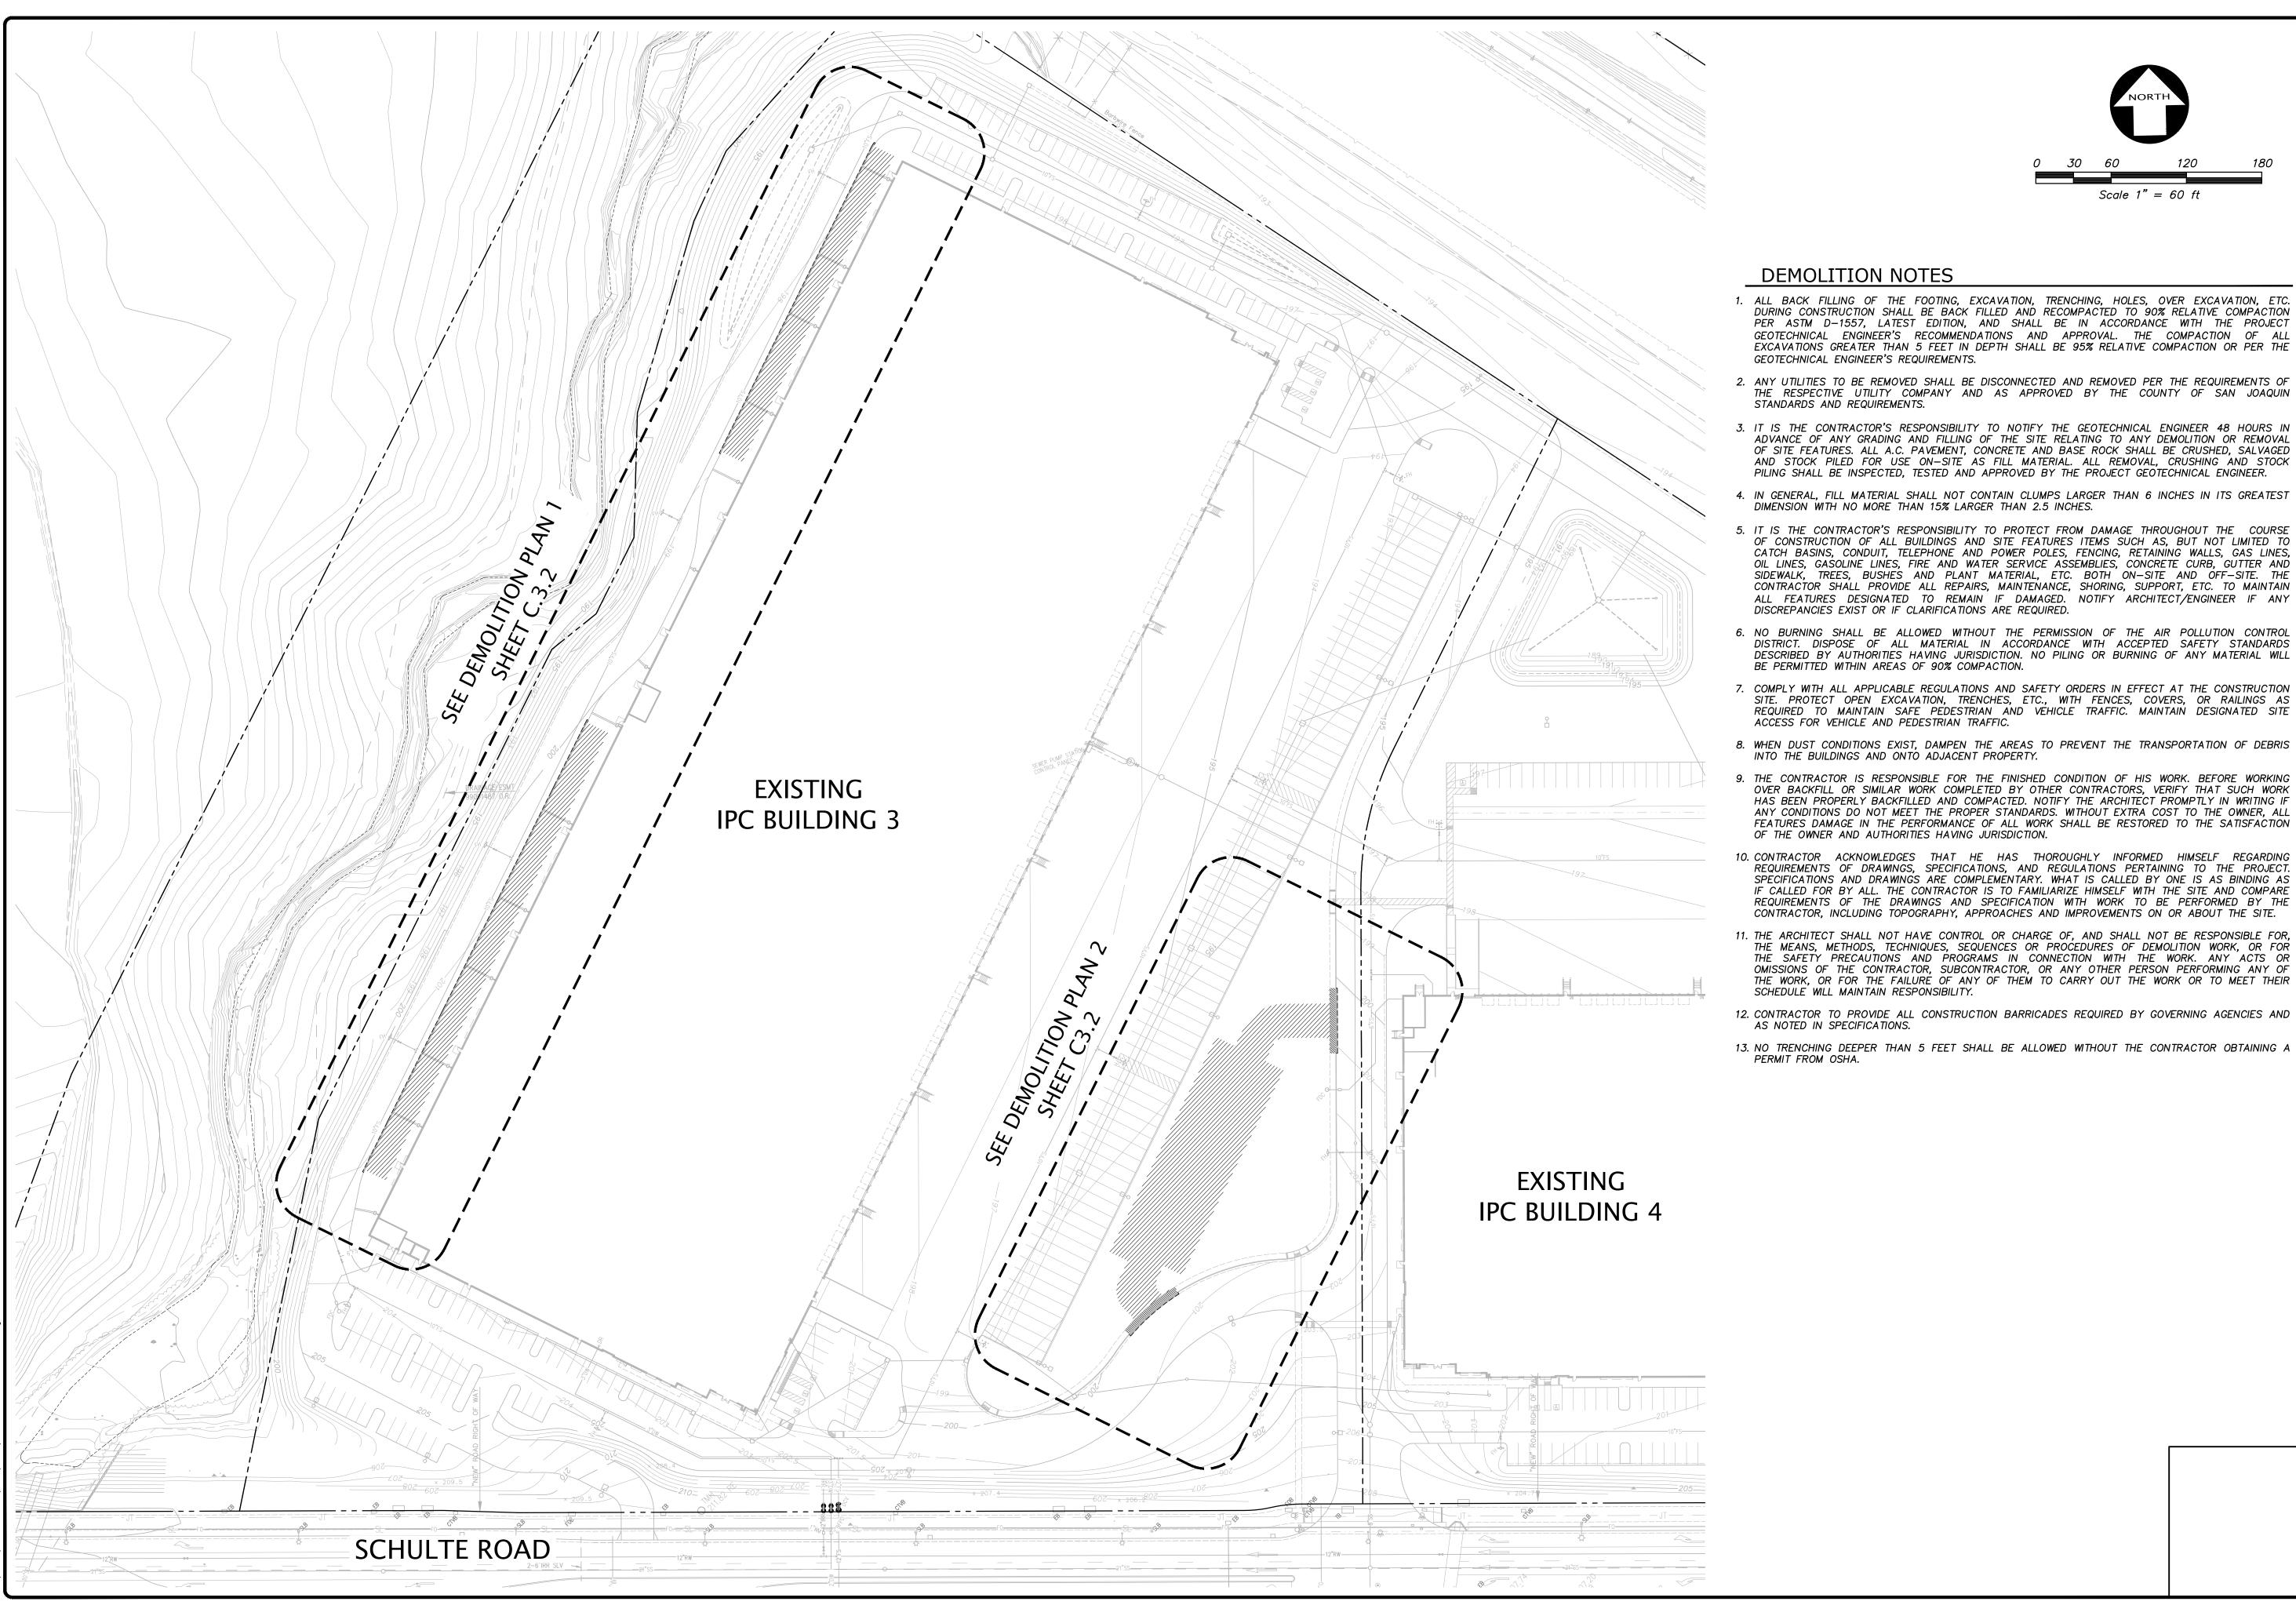

- 1. ALL BACK FILLING OF THE FOOTING, EXCAVATION, TRENCHING, HOLES, OVER EXCAVATION, ETC. DURING CONSTRUCTION SHALL BE BACK FILLED AND RECOMPACTED TO 90% RELATIVE COMPACTION PER ASTM D-1557, LATEST EDITION, AND SHALL BE IN ACCORDANCE WITH THE PROJECT GEOTECHNICAL ENGINEER'S RECOMMENDATIONS AND APPROVAL. THE COMPACTION OF ALL EXCAVATIONS GREATER THAN 5 FEET IN DEPTH SHALL BE 95% RELATIVE COMPACTION OR PER THE
- 2. ANY UTILITIES TO BE REMOVED SHALL BE DISCONNECTED AND REMOVED PER THE REQUIREMENTS OF THE RESPECTIVE UTILITY COMPANY AND AS APPROVED BY THE COUNTY OF SAN JOAQUIN
- 3. IT IS THE CONTRACTOR'S RESPONSIBILITY TO NOTIFY THE GEOTECHNICAL ENGINEER 48 HOURS IN ADVANCE OF ANY GRADING AND FILLING OF THE SITE RELATING TO ANY DEMOLITION OR REMOVAL OF SITE FEATURES. ALL A.C. PAVEMENT, CONCRETE AND BASE ROCK SHALL BE CRUSHED, SALVAGED AND STOCK PILED FOR USE ON-SITE AS FILL MATERIAL. ALL REMOVAL, CRUSHING AND STOCK PILING SHALL BE INSPECTED, TESTED AND APPROVED BY THE PROJECT GEOTECHNICAL ENGINEER.
- 4. IN GENERAL, FILL MATERIAL SHALL NOT CONTAIN CLUMPS LARGER THAN 6 INCHES IN ITS GREATEST
- OF CONSTRUCTION OF ALL BUILDINGS AND SITE FEATURES ITEMS SUCH AS, BUT NOT LIMITED TO CATCH BASINS, CONDUIT, TELEPHONE AND POWER POLES, FENCING, RETAINING WALLS, GAS LINES, OIL LINES, GASOLINE LINES, FIRE AND WATER SERVICE ASSEMBLIES, CONCRETE CURB, GUTTER AND SIDEWALK, TREES, BUSHES AND PLANT MATERIAL, ETC. BOTH ON-SITE AND OFF-SITE. THE CONTRACTOR SHALL PROVIDE ALL REPAIRS, MAINTENANCE, SHORING, SUPPORT, ETC. TO MAINTAIN ALL FEATURES DESIGNATED TO REMAIN IF DAMAGED. NOTIFY ARCHITECT/ENGINEER IF ANY
- 6. NO BURNING SHALL BE ALLOWED WITHOUT THE PERMISSION OF THE AIR POLLUTION CONTROL DISTRICT. DISPOSE OF ALL MATERIAL IN ACCORDANCE WITH ACCEPTED SAFETY STANDARDS DESCRIBED BY AUTHORITIES HAVING JURISDICTION. NO PILING OR BURNING OF ANY MATERIAL WILL
- 7. COMPLY WITH ALL APPLICABLE REGULATIONS AND SAFETY ORDERS IN EFFECT AT THE CONSTRUCTION SITE. PROTECT OPEN EXCAVATION, TRENCHES, ETC., WITH FENCES, COVERS, OR RAILINGS AS REQUIRED TO MAINTAIN SAFE PEDESTRIAN AND VEHICLE TRAFFIC. MAINTAIN DESIGNATED SITE
- 8. WHEN DUST CONDITIONS EXIST, DAMPEN THE AREAS TO PREVENT THE TRANSPORTATION OF DEBRIS
- 9. THE CONTRACTOR IS RESPONSIBLE FOR THE FINISHED CONDITION OF HIS WORK. BEFORE WORKING OVER BACKFILL OR SIMILAR WORK COMPLETED BY OTHER CONTRACTORS, VERIFY THAT SUCH WORK HAS BEEN PROPERLY BACKFILLED AND COMPACTED. NOTIFY THE ARCHITECT PROMPTLY IN WRITING IF ANY CONDITIONS DO NOT MEET THE PROPER STANDARDS. WITHOUT EXTRA COST TO THE OWNER, ALL FEATURES DAMAGE IN THE PERFORMANCE OF ALL WORK SHALL BE RESTORED TO THE SATISFACTION
- 10. CONTRACTOR ACKNOWLEDGES THAT HE HAS THOROUGHLY INFORMED HIMSELF REGARDING REQUIREMENTS OF DRAWINGS, SPECIFICATIONS, AND REGULATIONS PERTAINING TO THE PROJECT. SPECIFICATIONS AND DRAWINGS ARE COMPLEMENTARY. WHAT IS CALLED BY ONE IS AS BINDING AS IF CALLED FOR BY ALL. THE CONTRACTOR IS TO FAMILIARIZE HIMSELF WITH THE SITE AND COMPARE REQUIREMENTS OF THE DRAWINGS AND SPECIFICATION WITH WORK TO BE PERFORMED BY THE
- 11. THE ARCHITECT SHALL NOT HAVE CONTROL OR CHARGE OF, AND SHALL NOT BE RESPONSIBLE FOR, THE MEANS, METHODS, TECHNIQUES, SEQUENCES OR PROCEDURES OF DEMOLITION WORK, OR FOR THE SAFETY PRECAUTIONS AND PROGRAMS IN CONNECTION WITH THE WORK. ANY ACTS OR OMISSIONS OF THE CONTRACTOR, SUBCONTRACTOR, OR ANY OTHER PERSON PERFORMING ANY OF THE WORK, OR FOR THE FAILURE OF ANY OF THEM TO CARRY OUT THE WORK OR TO MEET THEIR
- 12. CONTRACTOR TO PROVIDE ALL CONSTRUCTION BARRICADES REQUIRED BY GOVERNING AGENCIES AND



BUILDING G ADDITION


AN

PL

10/03/2022 1" = 60

SCALE ENGINEER DRAWN BY


JOB NO. A09500-455

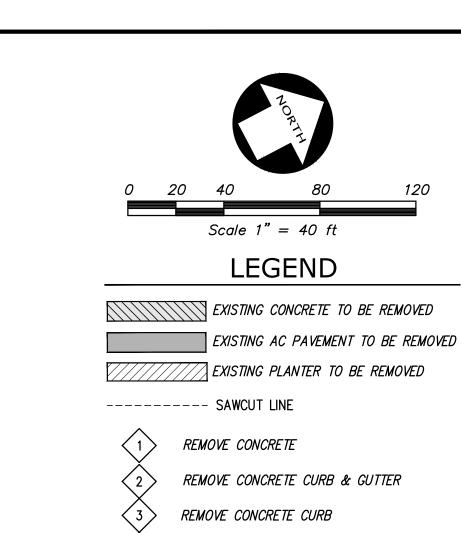


REMOVE PAVEMENT

REMOVE PLANTER

REMOVE PORTION OF CURB-O-LET

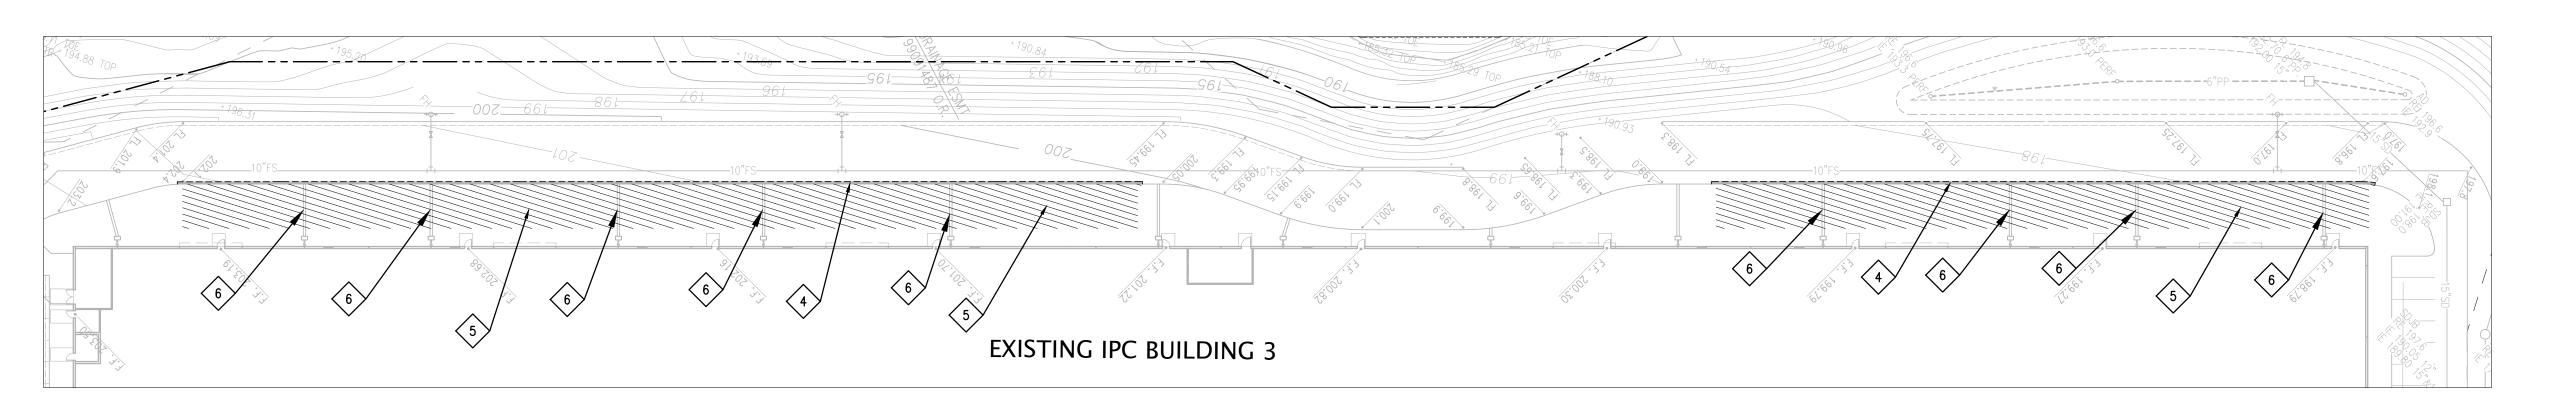

DEMOLITION PLAN 1 SCALE 1" = 40'

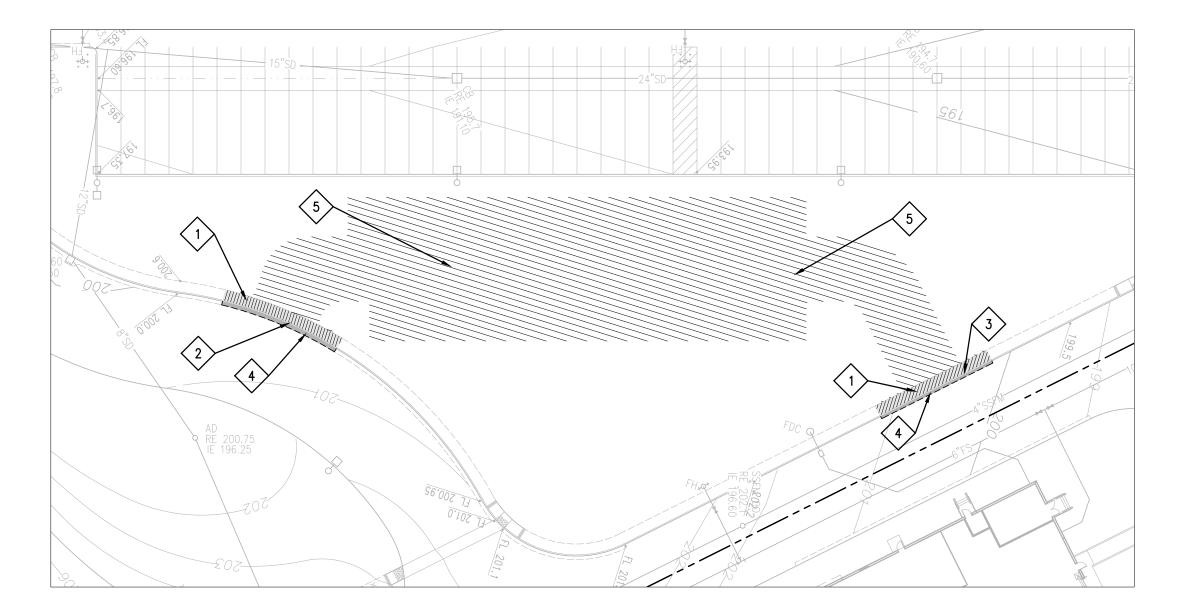

DEMOLITION DETAIL 2 SCALE 1" = 40'

REVISION BY 10/03/2022

PERMIT SUBM

No. 71814

F. BASSIT CONTROL

No. 71814

F. D. 12-81-30

S.A. J.E. OF CALIFORNIA

OF CALIFORNIA

Phone: (925) 245-8788 www.kierwriaht.com

2850 Collier Canvon Road

LIFORNIA

DEMOLITION PLAN

OF
I.P.C. - BUILDING 3

PARKING ADDITION

 DATE
 10/03/2022


 SCALE
 1" = 30'

 ENGINEER
 M.F.B.

 DRAWN BY
 R.S.

 JOB NO.
 A09500-455

C.3.2

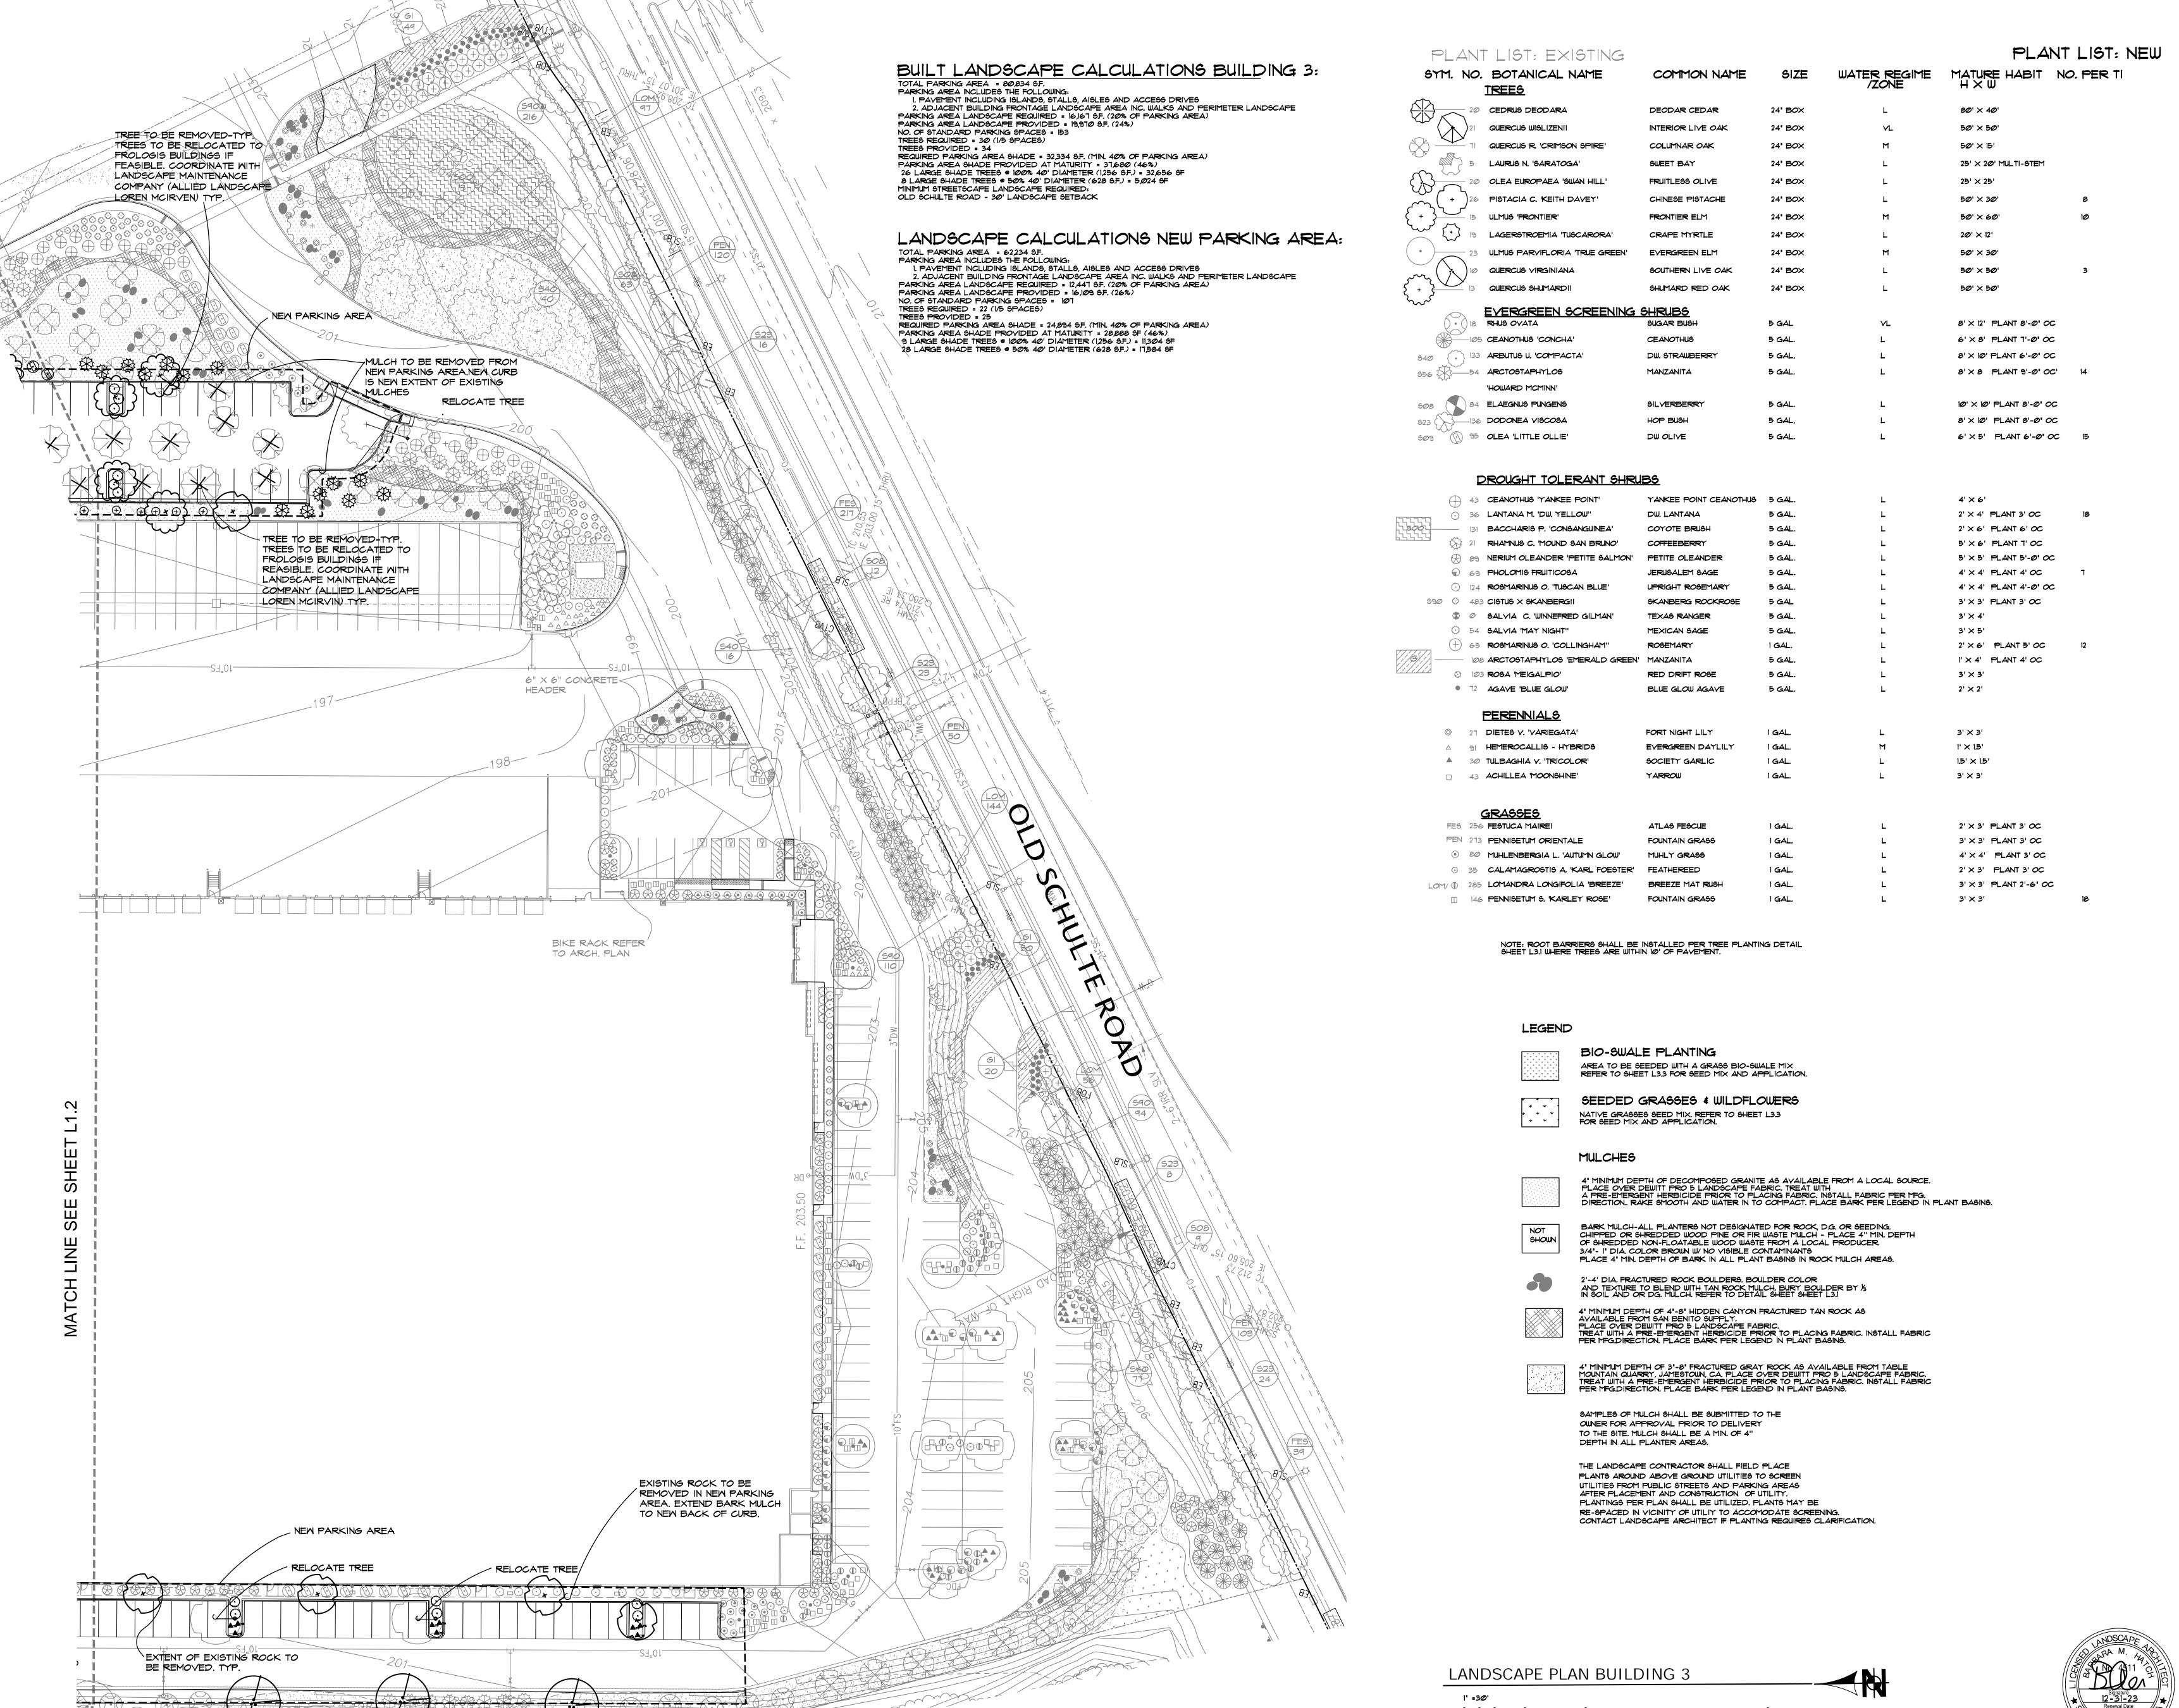

architecture

383 4th Street, Suite 101 Oakland, CA tel: 949 •863 •1770 fax: 949 • 863 • 0851 email: hpa@hparchs.com

Green Design Landscape Architects, Inc. 1464 Popinjay Drive Reno, NV. p: 775 829 1364 email: bhatch00@charter.net

Owner:



3353 Gateway Blvd.

Fremont, CA 94538

tel: (510) 656-1900

PROLOGIS

Project:

International Park of

Tenant Improvement

Tracy, CA

Consultants: Kier & Wrigh **MECHANICAL** PLUMBING

Green Design

LECTRICAL LANDSCAPE IRE PROTECTION


SOILS ENGINEER

TI LANDSCAPE PLAN BUILDING 3

Project Number: Drawn by: 09/30/22

Revision:

Sheet:

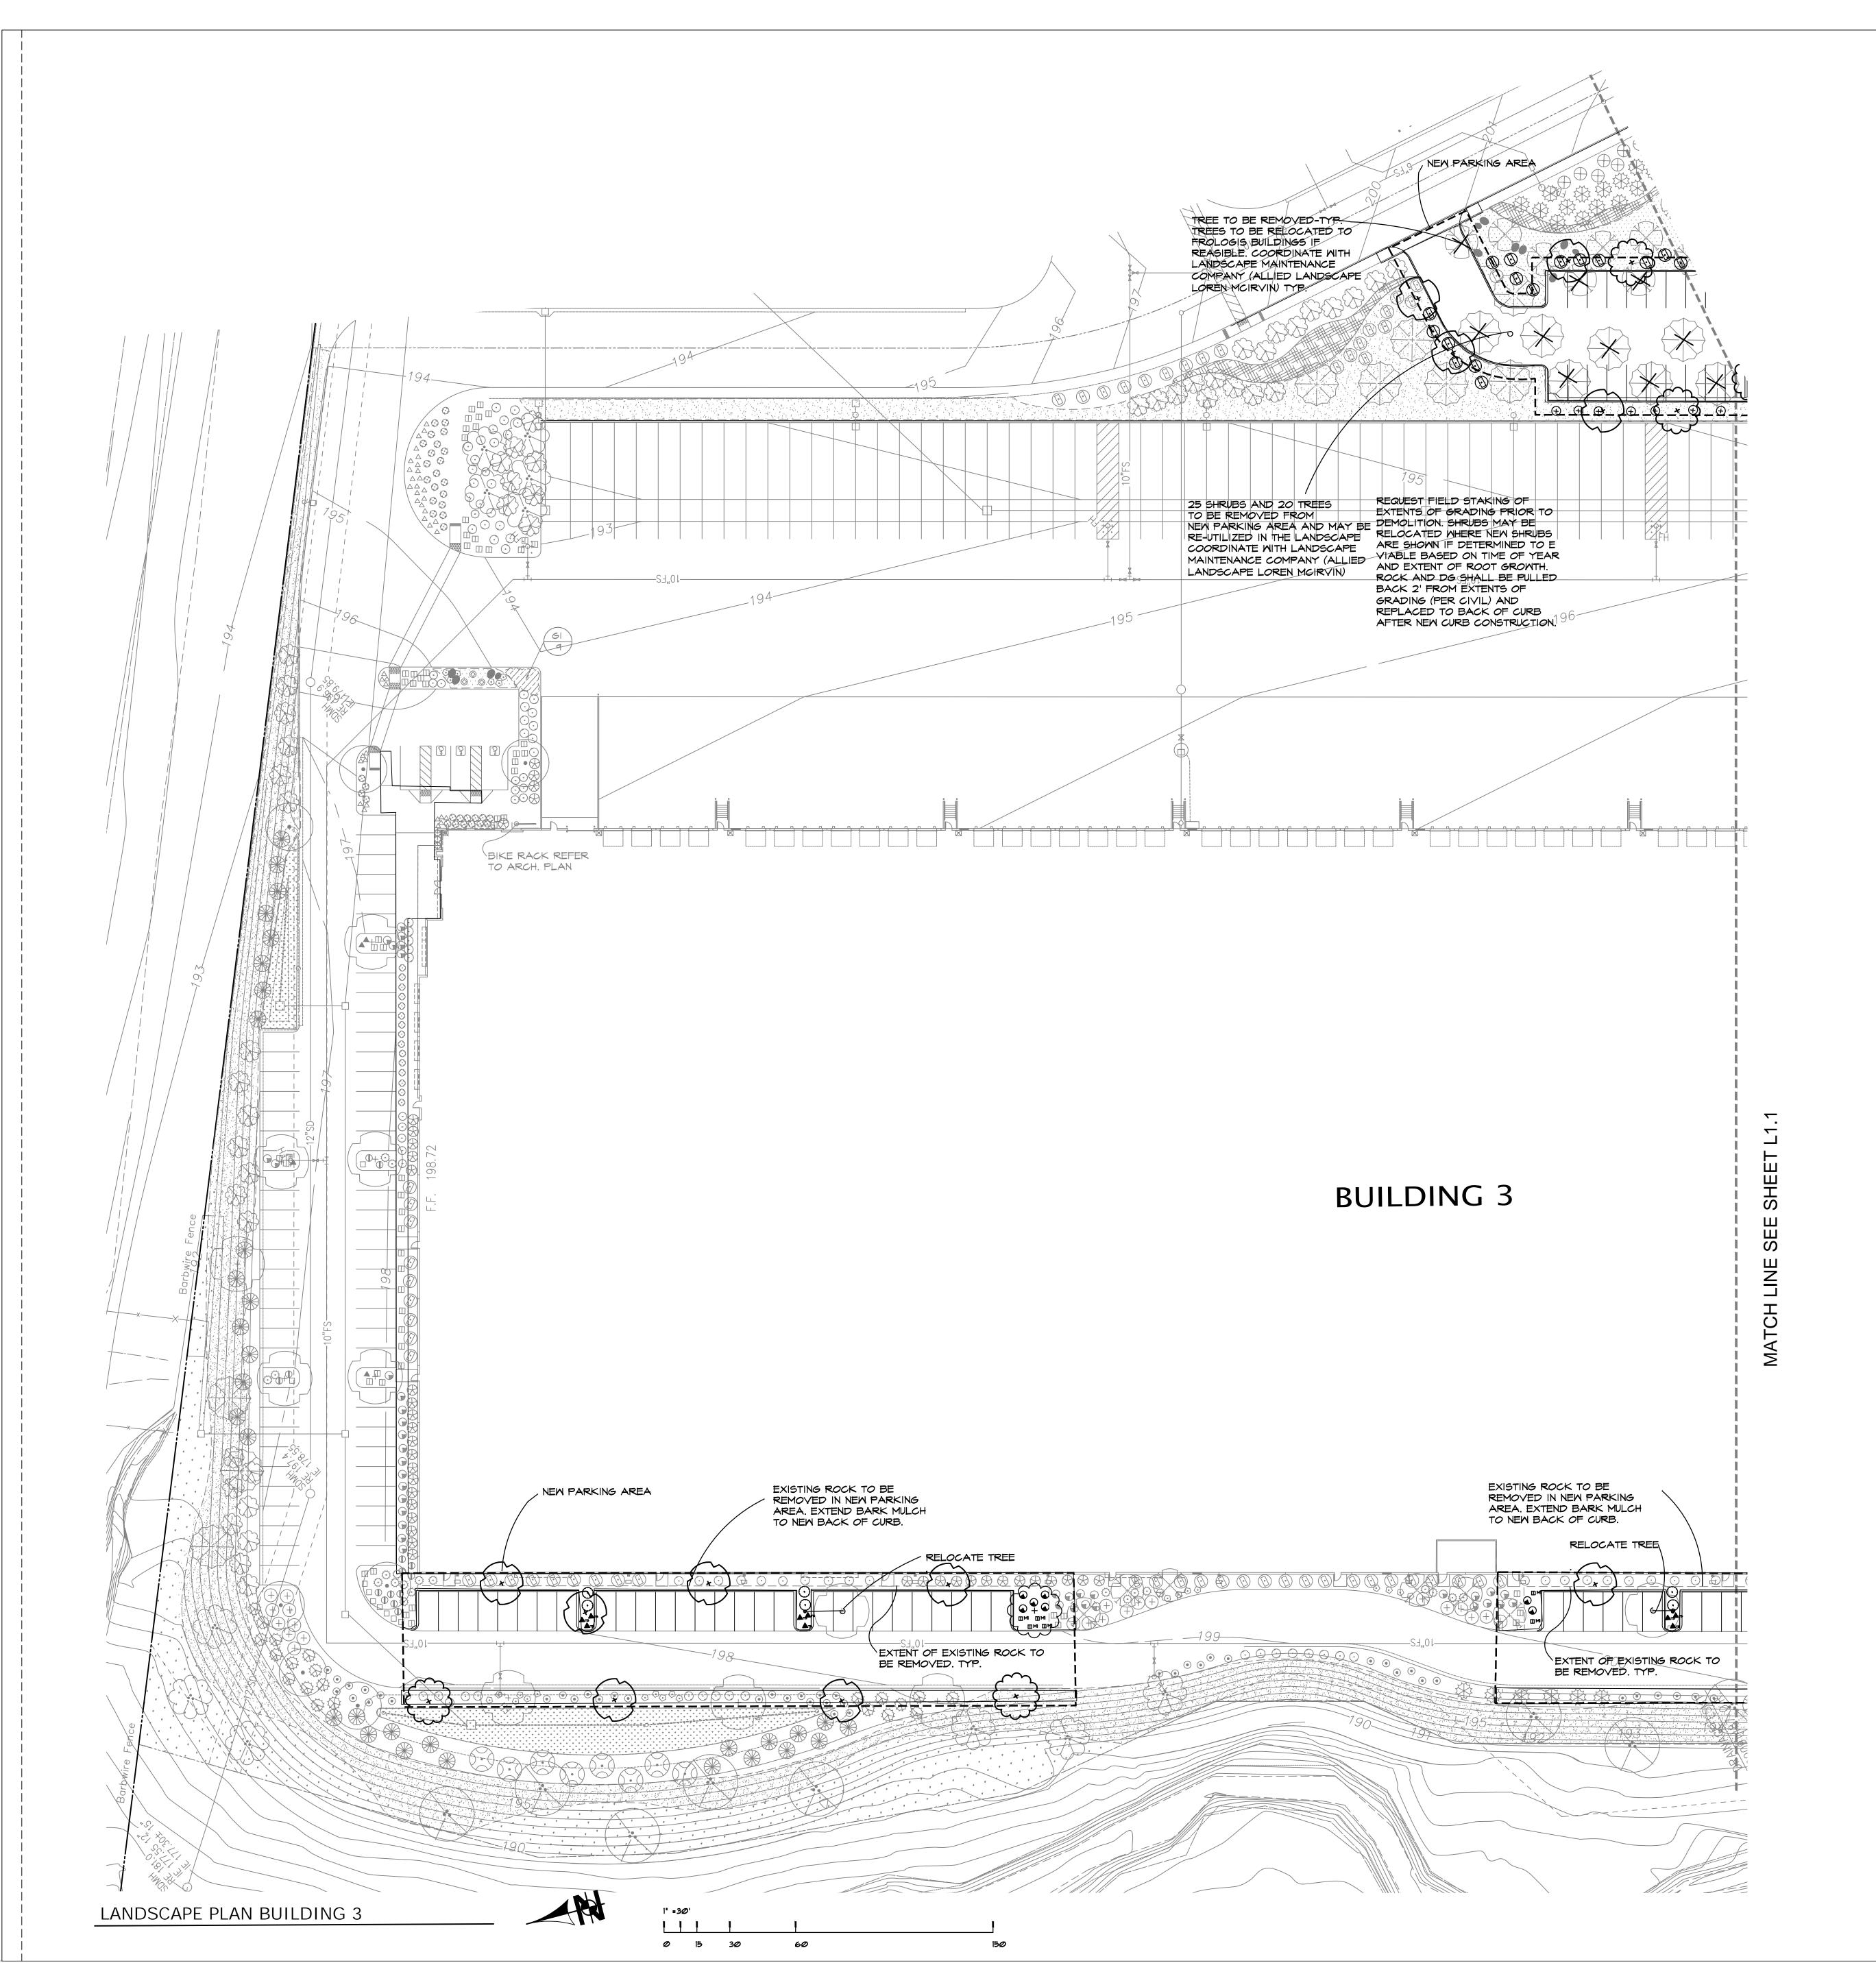

LANDSCAPE NOTES:

THE CONTRACTOR SHALL GUARANTEE ALL PLANT MATERIALS
FOR ONE FULL YEAR UPON FINAL ACCEPTANCE OF THE PROJECT.
THE CONTRACTOR SHALL MAINTAIN THE SITE INCLUDING WATER
SCHEDULING AND MOWING, FOR THE ONE YEAR GUARANTEE PERIOD.
ANY PLANTS REPLACED UNDER THIS GUARANTEE SHALL BE GUARANTEED
FOR ONE FULL YEAR FROM THE DATE OF REPLACEMENT.

FOR ONE FULL YEAR FROM THE DATE OF REPLACEMENT.
TAG ALL REPLACED PLANT MATERIAL WITH REPLACEMENT DATE.

SOIL IN THE PLANTER AREAS SHALL BE AMENDED PER

A SOIL ANALYSIS REPORT AND RECOMMENDATIONS PREPARED

BY AN AGRICULTURAL SUITABILITY SOIL TESTING SERVICE AFTER PLANTERS ARE BROUGHT TO GRADE PER CIVIL GRADING PLAN. ALL SOIL ANALYSIS AND REPORTS SHALL SATISFY THE REQUIREMENTS OF 492.5 IN THE CALIFORNIA WATER EFFICIENT LANDSCAPE ORDINANCE FOR A SOIL MANAGEMENT REPORT. THE RESPONSIBILITY OF PREPARATION THIS REPORT SHALL BE THE LANDSCAPE CONTRACTOR'S RESPONSIBILITY. THE CONTRACTOR SHALL SUBMIT THE REPORT TO THE GENERAL CONTRACTOR FOR SUBMITTAL TO THE CITY. SHRUB PLANTERS: COLLECT A MINIMUM OF 16 SOIL SAMPLES FROM ONSITE PLANTER AREAS AFTER PLANTERS HAVE BEEN BROUGHT TO GRADE. THOROUGHLY MIX THE COLLECTED SAMPLES AND SUBMIT ONE MIXED SAMPLE FOR ANALYSIS WITH RECOMMENDATIONS FOR ORGANIC SOIL AMENDMENT. PLANTER AREA SOILS SHALL BE AMENDED PER THE SOIL ANALYSIS RECOMMENDATIONS TO A MIN. DEPTH OF 6" PRIOR TO PLANTING. AT MINIMUM 6 CY OF COMPOST PER 1000 S.F. SHALL BE INCORPORATED INTO THE TOP 6" OF PLANTER SOIL. PLANTER AREAS: LOOSEN SOIL TO A DEPTH OF 12" PRIOR TO AMENDING. SPREAD AMENDMENT AND INCORPORATE PER SOIL ANALYSIS RECOMMENDATIONS OR MIN. STATED WHICH EVER IS GREATER. RAKE OUT ALL ROCK AND DEBRIS GREATER THAN I 1/2" DIA. RAKE TO AN EVEN GRADE. SOIL REPORT SHALL INCLUDE SOIL INFILTRATION RATE FOR IRRIGATION SCHEDULING. PLANT BACKFILL SHALL BE AMENDED AT THE TIME OF PLANTING PER THE SOIL RECOMMENDATIONS. IN ROCK MULCH AREAS WHERE SHRUBS AND OR TREES ARE AT A MINIMUM OF 10' OC, SOIL AMENDING MAY BE PROVIDED PER INDIVIDUAL PLANT PIT BACKFILL ONLY. ALL PLANTS SHALL BE SPRAYED WITH VERMA-PLEX OR EQUAL ORGANIC FOLIAR FERTILIZER AFTER INSTALLATION. SOIL SHALL NOT BE TILLED OR AMENDED WITHIN THE DRIP LINE OF EXISTING TREES IF PRESENT ONSITE. A COPY OF THE SOIL ANALYSIS AND SOIL AMENDMENTS INCORPORATED SHALL BE SUBMITTED THE OWNER AND THE CITY AS PART OF THE PROJECT LANDSCAPE DOCUMENTATION PACKAGE.

PER SYMBOLS AND SPACING INDICATED ON THE PLAN. SYMBOLS PREVAIL OVER QUANTITIES LISTED IN THE PLANT LEGEND.

24 HR. MIN. NOTICE TO THE OWNER REPRESENTATIVE REQUIRED

FOR PLANT MATERIAL REVIEW PRIOR TO PLANTING.
ALL PLANT SUBSTITUTIONS SHALL BE APPROVED BY THE
LANDSCAPE ARCHITECT.
ALL PLANTS NOT MEETING OR EXCEEDING REQUIREMENTS AND RECOMMENDA-

TIONS OF ANSI 260.1 "AMERICAN STANDARD FOR NURSERY STOCK" SHALL BE REJECTED. THE CONTRACTOR SHALL RECEIVE ON-SITE APPROVAL OF PLANT MATERIAL BY THE OWNER'S REPRESENTATIVE PRIOR TO PLANTING. FAILURE TO RECEIVE APPROVAL PRIOR TO PLANTING MAY RESULT IN REJECTION AND THE CONTRACTOR SHALL REPLACE ALL REJECTED PLANT MATERIAL AT HIS EXPENSE. THE OWNER RESERVES THE RIGHT TO INSPECT AND EVALUATE PLANT MATERIAL THROUGHOUT THE CONSTRUCTION AND MAINTENANCE PERIOD.

THE CONTRACTOR IS RESPONSIBLE FOR NOTIFYING THE OWNERS REPRESENTATIVE A MIN. OF 48 HOURS IN ADVANCE FOR THE FOLLOWING SITE OBSERVATIONS AND/OR MEETINGS.

A. PRECONSTRUCTION MEETING WITH ALL PARTIES.

B. PLANT MATERIAL ON SITE, PRIOR TO INSTALLATION.

C. PLANT LOCATIONS STAKED, PRIOR TO PLANTING.

D. FINAL PROJECT WALK-THROUGH

E. ADDITIONAL SITE OBSERVATIONS DETERMINED BY THE

IT IS THE RESPONSIBILITY OF THE CONTRACTOR TO LOCATE AND PROVIDE PLANT MATERIAL AS SPECIFIED ON THIS PLAN. THE CONTRACTOR
MAY SUBMIT A REQUEST TO PROVIDE SUBSTITUTIONS FOR THE
SPECIFIED PLANT MATERIAL UNDER THE FOLLOWING CONDITIONS:
A. ANY SUBSTITUTIONS PROPOSED SHALL BE SUBMITTED TO THE
OWNER'S REPRESENTATIVE WITHIN TWO WEEKS OF THE AWARD OF
CONTRACT. SUBSTITUTIONS MUST MEET EQUIVALENT DESIGN AND
FUNCTIONAL GOALS OF THE ORIGINAL PLANT MATERIAL AS
DETERMINED BY THE OWNER'S REPRESENTATIVE. ANY CHANGES
MUST HAVE THE APPROVAL OF THE OWNER'S REPRESENTATIVE.
B. THE REQUEST MUST BE ACCOMPANIED BY AT LEAST THREE
NOTICES FROM PLANT SUPPLIERS THAT THE PLANT MATERIAL
SPECIFIED IS NOT AVAILABLE PRIOR TO THE CONSTRUCTION

OWNER'S REPRESENTATIVE OR CONTRACTOR.

THE CONTRACTOR IS RESPONSIBLE FOR PROVIDING PLANT MATERAIL PER SYMBOLS AND SPACING INDICATED ON THE PLAN. SYMBOLS PREVAIL OVER QUANTITIES LISTED IN THE PLANT LEGEND.

THE CONTRACTOR SHALL COORDINATE WITH THE OWNER'S SITE SUPERINTENDENT IN VARIFIYING ELEVATION OF FINISHED GRADE PER CIVIL IS COMPLETE AND IN PLACE PRIOR TO START OF WORK.

THE LANDSCAPE CONTRACTOR SHALL INSURE POSITIVE DRAINAGE IN ALL PLANTER AREAS PER CIVIL ENGINEERS GRADING PLAN AFTER MOUNDING/LANDSCAPE IMPROVEMENTS ARE COMPLETE.

PROVIDE I DIGITAL COPY OF SUBMITTAL PACKAGE OF ALL

BY LANDSCAPE ARCHITECT PRIOR TO COMMENCING WORK.

LANDSCAPE COMPONENTS AND MATERIALS FOR APPROVAL

HPA architecture

> HPA, Inc. 383 4th Street, Suite 101 Oakland, CA 94607

> > tel: 949 •863 •1770

fax: 949 • 863 • 0851

email: hpa@hparchs.com

Creen Design

Landscape Architects, Inc.

1464 Popinjay Drive
Reno, NV.

p: 775 829 1364

email: bhatch00@charter.net







3353 Gateway Blvd. Fremont, CA 94538 tel: (510) 656-1900



International Park of Commerce IPC 3 Tenant Improvement

Tracy, CA



Consultants:

CIVIL Kier & Wright
STRUCTURAL MECHANICAL PLUMBING ELECTRICAL LANDSCAPE Green Design

SOILS ENGINEER

FIRE PROTECTION

Title:


PLAN BUILDING 3

Project Number: 22608
Drawn by: BH
Date: 09/30/22

Revision:

Sheet

L1.

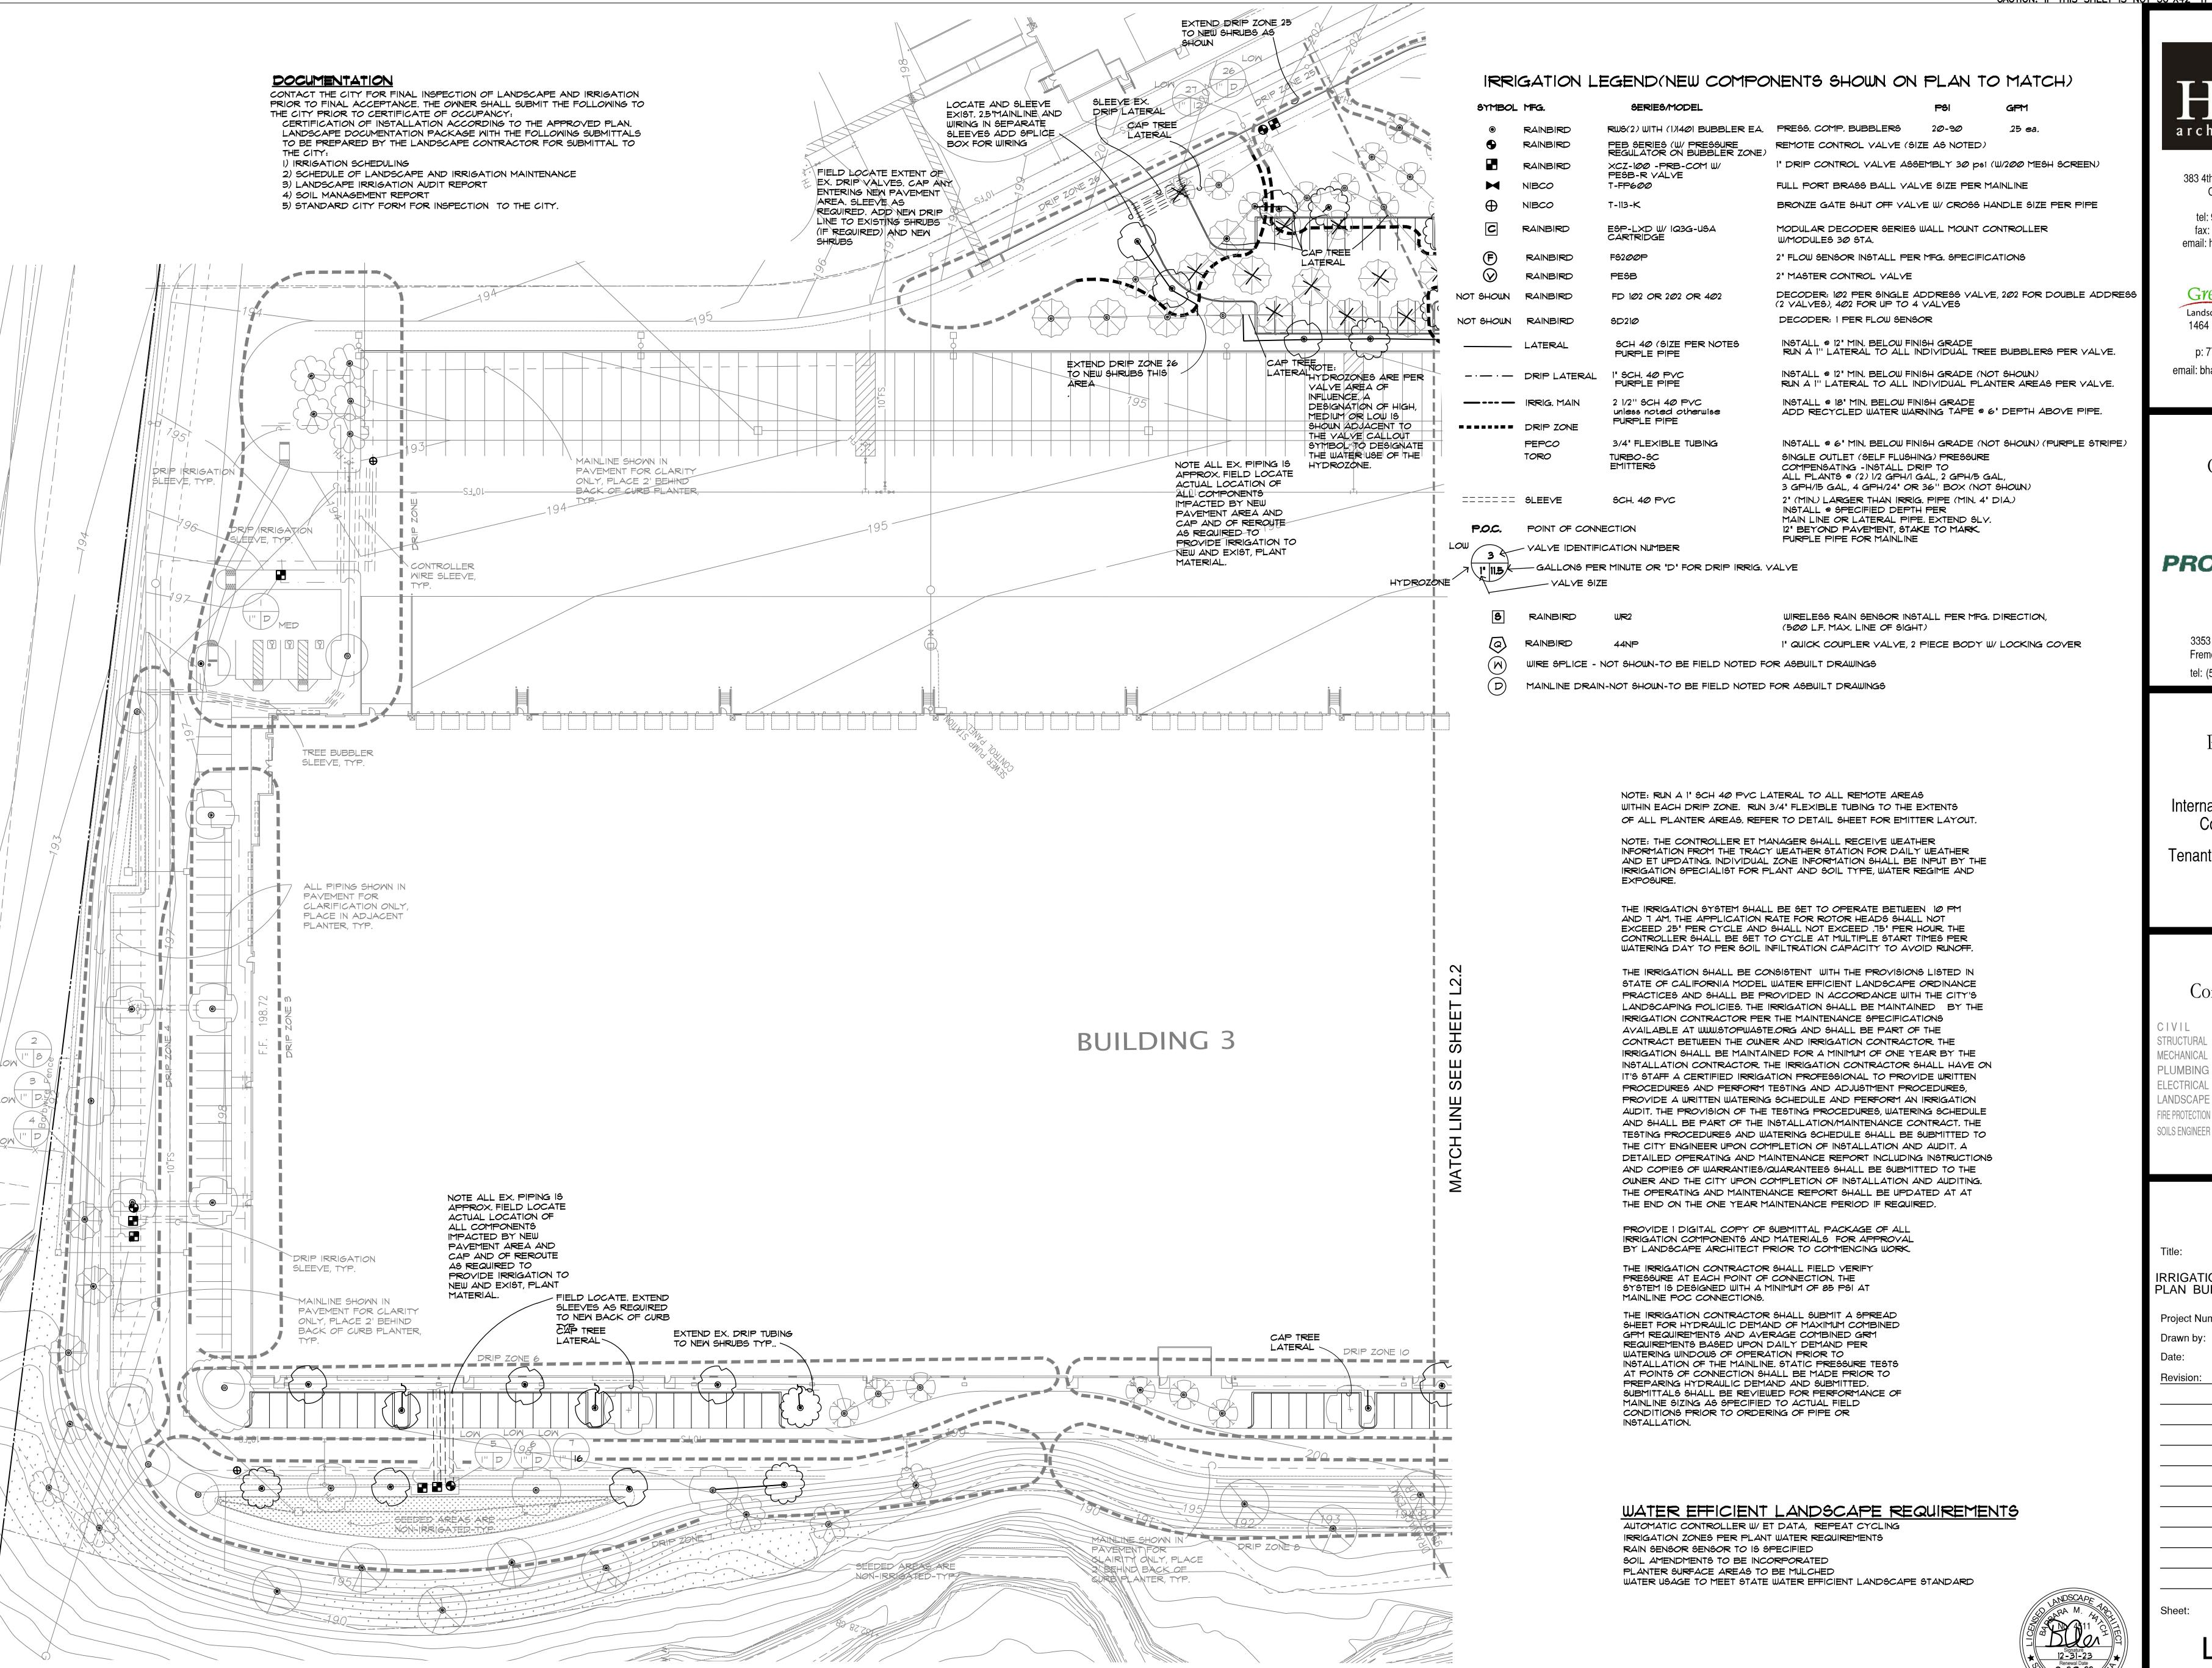

IRRIGATION PLAN BUILDING 3

SCALE: 1" = 30'-0"



HPA, Inc. 383 4th Street, Suite 101 Oakland, CA 94607 tel: 949 •863 •1770 fax: 949 • 863 • 0851

email: hpa@hparchs.com

Green Design Landscape Architects, Inc. 1464 Popinjay Drive Reno, NV. p: 775 829 1364

email: bhatch00@charter.net

Owner:



3353 Gateway Blvd. Fremont, CA 94538 tel: (510) 656-1900



International Park of Commerce Tenant Improvement

Tracy, CA




Kier & Wrigh STRUCTURAL **MECHANICAL** PLUMBING LECTRICAL LANDSCAPE Green Design FIRE PROTECTION

IRRIGATION PLAN BUILDING 3

> Project Number: Drawn by: 09/30/22 PLAN Revision:

Sheet:

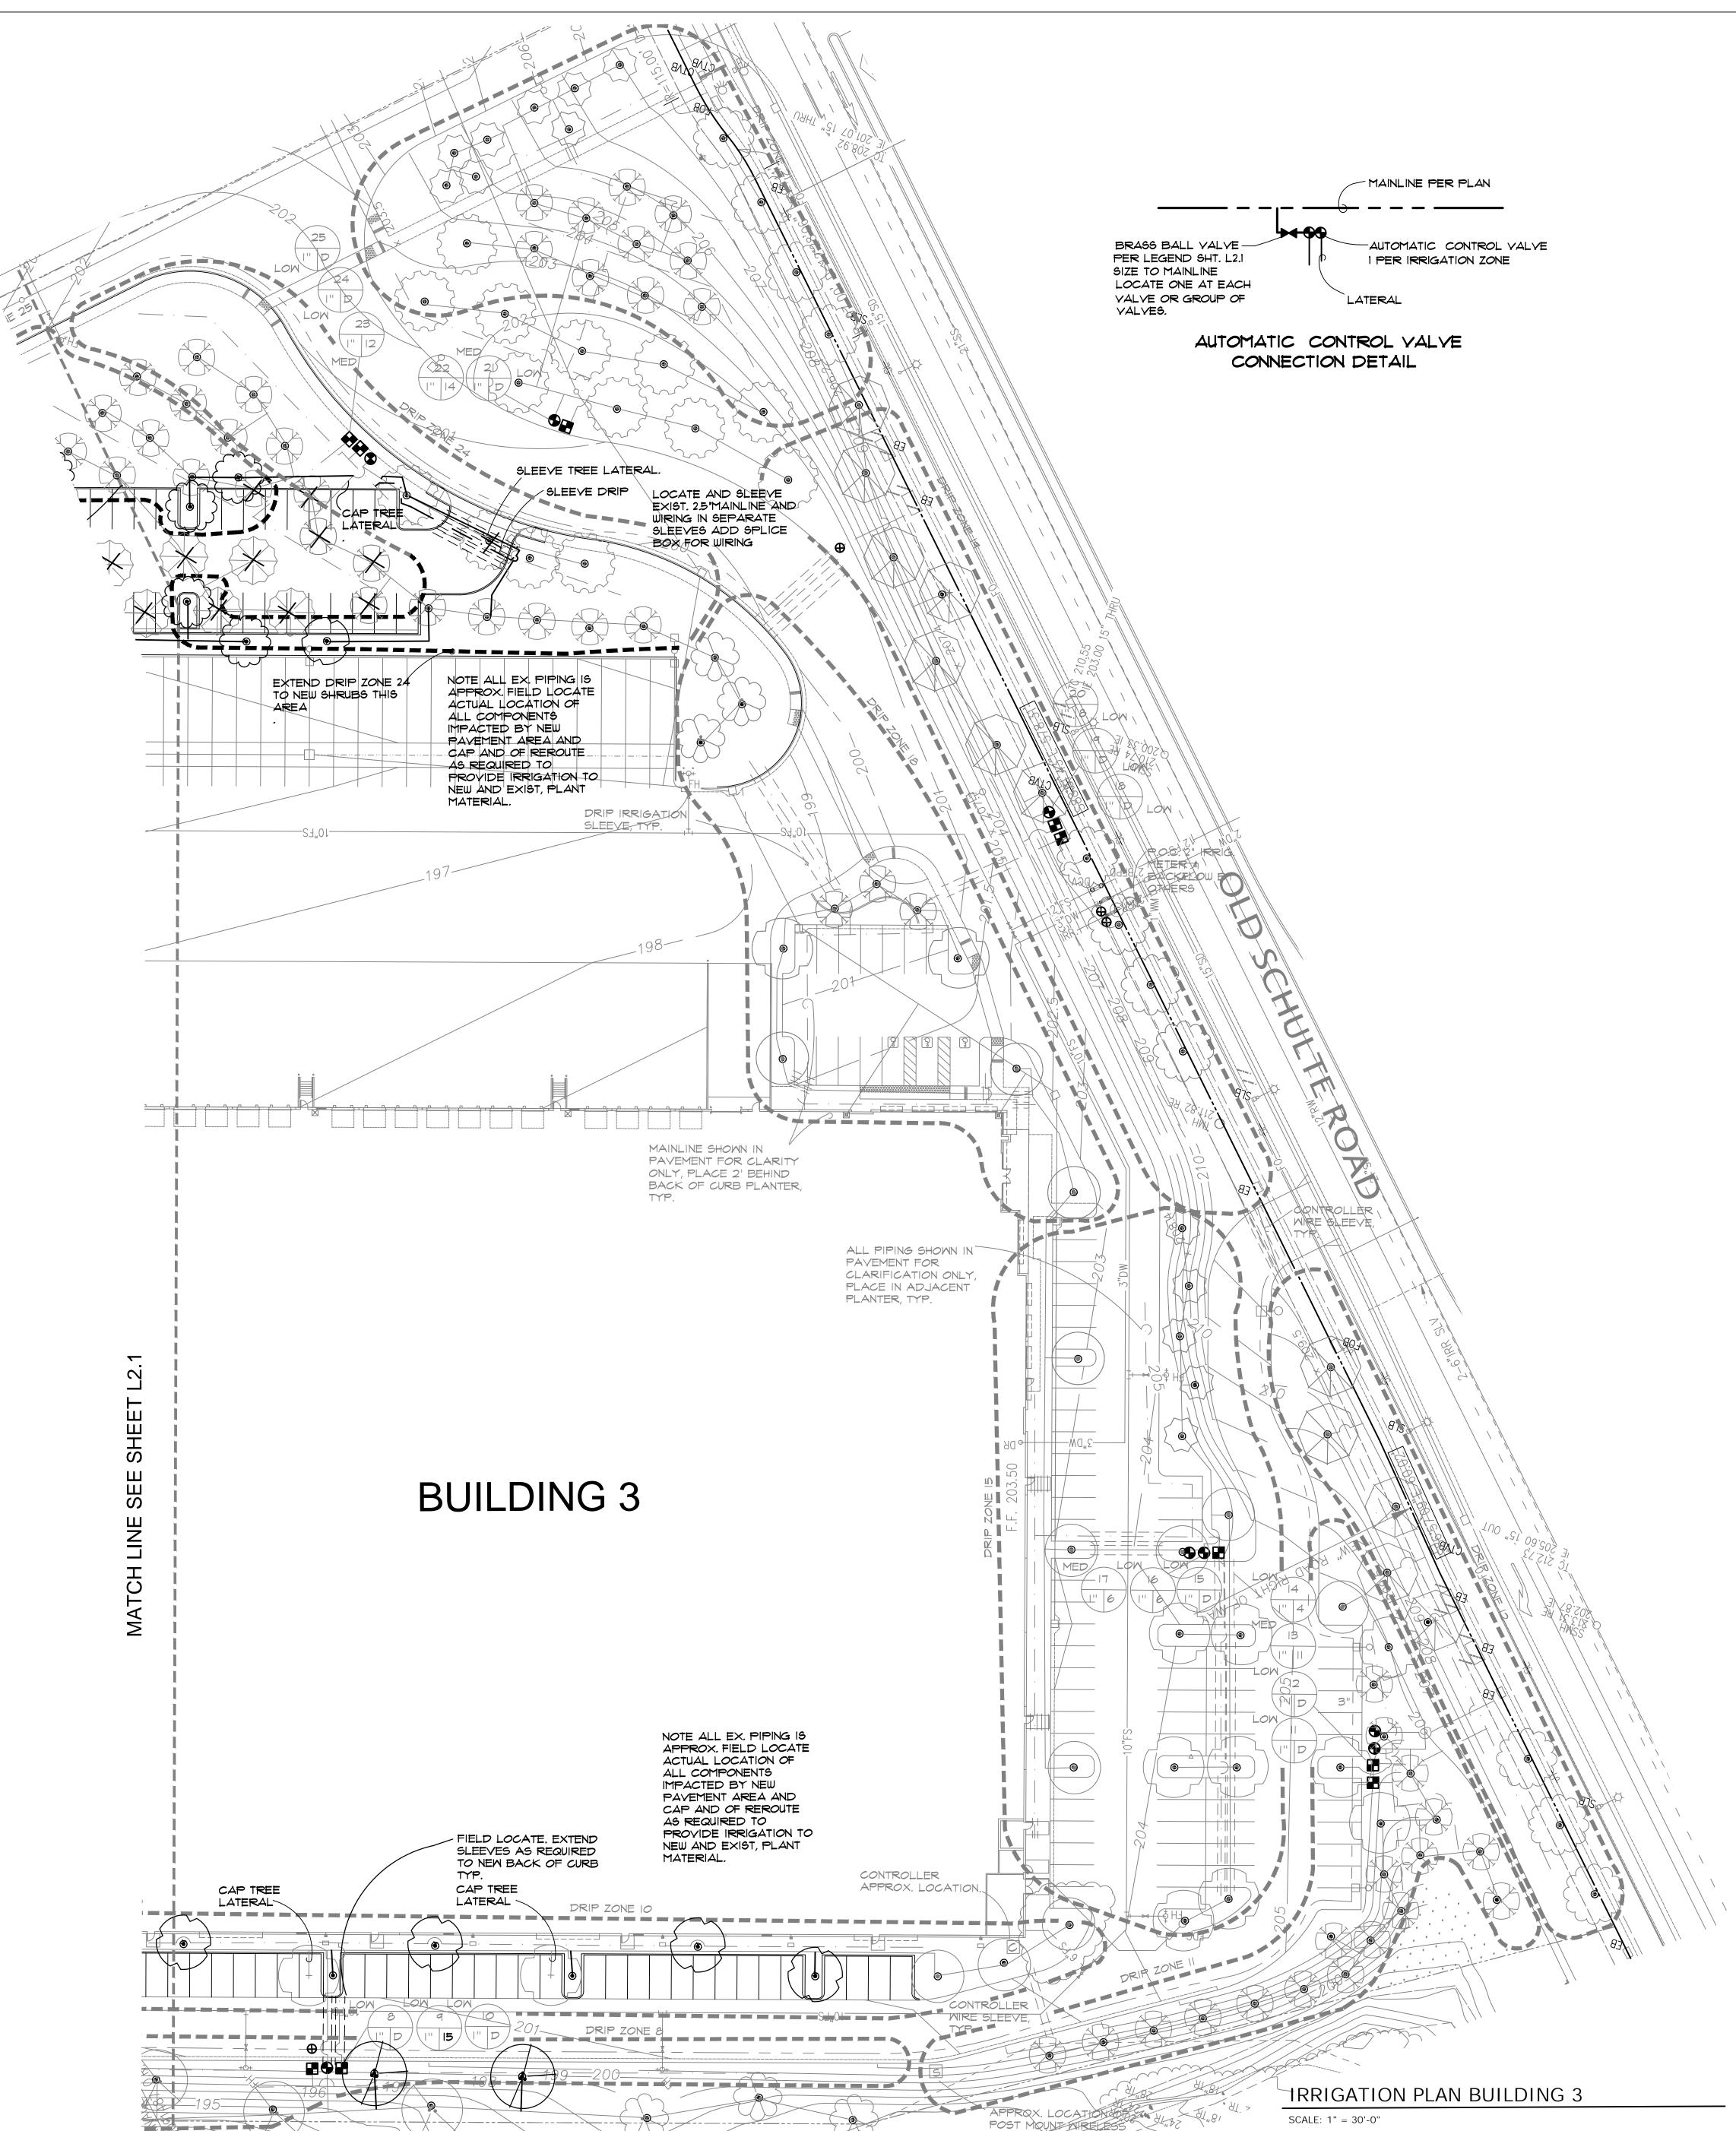

RAIN SENSOR

ORIGINAL PLAN IRRIGATION NOTES

1. ALL MATERIALS AND CONSTRUCTION SHALL BE IN ACCORDANCE WITH THESE PLANS, THE REQUIREMENTS OF THE CITY, THE STANDARD SPECIFICATIONS FOR PUBLIC WORKS CONSTRUCTION, LOCAL BUILDING CODES, ORDINANCES, AND OTHER CODES OR REGULATIONS THAT APPLY.

2. SLEEVES ARE NOT SHOWN AT PAVEMENT CROSSINGS.
ALL PIPING AND WIRING UNDER PAVING SHALL BE INSTALLED IN
SLEEVES. IT IS THE CONTRACTOR'S RESPONSIBILITY TO
COORDINATE ALL SLEEVING WITH THE GENERAL CONTRACTOR.
FAILURE OF INSTALLING SLEEVES PRIOR TO PAVING SHALL BE
THE LANDSCAPE CONTRACTOR'S RESPONSIBILITY AND SHALL BE
INSTALLED AS HIS EXPENSE.

PIPING AND CONTROL WIRES UNDER PAVEMENT SHALL BE INSTALLED IN SEPARATE SLEEVES. LATERAL SLEEVES SHALL BE A MINIMUM OF 18" DEPTH, MAINLINE SLEEVES SHALL BE A MINIMUM 24" DEPTH. SLEEVE SIZE SHALL BE A MINIMUM OF TWICE (2X) O.D. DIAMETER OF THE PIPE TO BE SLEEVED. CONTROLLER WIRE SLEEVES SHALL BE 2X THE SIZE FOR THE REQUIRED NUMBER OF WIRES. BACKFILL MIN. 4" SAND.

3. MAINLINE SLEEVES UNDER PAVEMENT SHALL BE INSTALLED 18" BELOW THE SUBGRADE. THE TRENCH SHALL BE CLEANED FREE OF ALL ROCK & DEBRIS, AND BACKFILLED WITH SAND TO A MINIMUM DEPTH OF 4" OVER THE SLEEVE OVER AND UNDER THE SLEEVE. BACKFILL TRENCH WITH 1/8" MINUS.

4. ALL MAIN LINES SHALL BE PRESSURE TESTED AT 120 PSI FOR A MINIMUM 2.5 HOUR PERIOD PRIOR TO BACKFILLING OF TRENCHES. IF ANY LEAKS ARE PRESENT THEY SHALL BE CORRECTED AND LINES SHALL BE RE-TESTED PRIOR TO BACKFILLING TRENCHES.

5. PIPE SIZES SHALL CONFORM TO THOSE SHOWN ON THE DRAWINGS. NO SUBSTITUTIONS OF SMALLER PIPE SIZES SHALL BE PERMITTED, BUT SUBSTITUTIONS OF LARGER SIZES MAY BE APPROVED. ALL DAMAGED AND REJECTED PIPE SHALL BE REMOVED FROM THE SITE AT THE TIME OF SAID REJECTION.

6. THE IRRIGATION CONTRACTOR SHALL FLUSH ALL LATERALS PRIOR TO INSTALLING EMITTER HEADS.

T. THIS DESIGN IS DIAGRAMMATIC. ALL PIPING, VALVES, ETC., SHOWN OUTSIDE OF THE PLANTER AREAS IS FOR DESIGN CLARIFICATION ONLY AND SHALL BE INSTALLED IN THE PLANTER AREAS.

8. IT IS THE RESPONSIBILITY OF THE IRRIGATION CONTRACTOR TO FAMILIARIZE HIMSELF WITH ALL GRADE DIFFERENCES, LOCATION OF WALLS, RETAINING WALLS, STRUCTURES AND UTILITIES. THE IRRIGATION CONTRACTOR SHALL REPAIR OR REPLACE ALL ITEMS DAMAGED BY HIS WORK. HE SHALL COORDINATE HIS WORK WITH OTHER CONTRACTORS, FOR THE LOCATION AND INSTALLATION OF PIPE SLEEVES AND LATERALS UNDER ROADWAYS AND PAYING.

9. SHOULD DISCREPANCIES IN THE PLANS OR FIELD MODIFICATIONS BE REQUIRED, CONTACT THE LANDSCAPE ARCHITECT PRIOR TO CONSTRUCTION FOR RESOLUTION OR CLARIFICATION.

10. DO NOT WILLFULLY INSTALL THE IRRIGATION SYSTEM AS SHOWN ON THE DRAWINGS WHEN IT IS OBVIOUS IN THE FIELD THAT UNKNOWN OBSTRUCTIONS, GRADE DIFFERENCES OR DIFFERENCES IN THE AREA DIMENSIONS EXIST THAT MIGHT NOT HAVE BEEN CONSIDERED IN THE ENGINEERING. SUCH OBSTRUCTIONS OR DIFFERENCES SHOULD BE BROUGHT TO THE ATTENTION OF THE LANDSCAPE ARCHITECT. IN THE EVENT THIS NOTIFICATION IS NOT PERFORMED, THE IRRIGATION CONTRACTOR SHALL ASSUME FULL RESPONSIBILITY FOR ANY REVISIONS NECESSARY.

11 ALL IRRIGATION EQUIPMENT NOT OTHERWISE DETAILED OR SPECIFIED SHALL BE INSTALLED AS PER MANUFACTURER'S RECOMMENDATIONS AND SPECIFICATIONS.

12. THE CONTRACTOR SHALL AT HIS OWN EXPENSE, LOCATE ALL UNDERGROUND UTILITIES WHICH MAY AFFECT HIS OPERATION DURING CONSTRUCTION AND SHALL TAKE ALL NECESSARY PRECAUTIONS TO AVOID DAMAGE TO THE SAME.

13. THE CONTRACTOR SHALL USE EXTREME CAUTION WHEN WORKING NEAR OVERHEAD OR UNDERGROUND POWER AND/OR TELEPHONE, WATER, GAS AND SEWER FACILITIES SO AS TO SAFELY PROTECT ALL UTILITIES, PERSONNEL, AND EQUIPMENT, AND SHALL BE RESPONSIBLE FOR ALL COSTS AND LIABILITY IN CONNECTION THEREWITH.

14. THE CONTRACTOR SHALL TAKE ALL PRECAUTIONARY MEASURES NECESSARY TO PROTECT EXISTING IMPROVEMENTS WHICH ARE TO REMAIN IN PLACE, FROM DAMAGE, AND ALL SUCH IMPROVEMENTS DAMAGED BY THE CONTRACTOR'S OPERATIONS SHALL BE REPAIRED OR RECONSTRUCTED SATISFACTORY TO THE OWNER AT THE EXPENSE OF THE CONTRACTOR.

15. AN OPEN TRENCH INSPECTION OF THE REDUCED PRESSURE PRINCIPLE BACKFLOW DEVICE SHALL BE PERFORMED BY THE WATER PURVEYOR PRIOR TO OPERATING THE IRRIGATION SYSTEM

16. THE IRRIGATION CONTROLLER SHALL BE WIRED DIRECTLY TO THE POWER SOURCE. IT SHALL BE THE RESPONSIBILITY OF THE LANDSCAPE CONTRACTOR TO BRING CONTROLLER WIRING TO THE CONTROLLER LOCATION. CONNECTING THE CONTROLLER TO THE POWER SOURCE SHALL BE THE RESPONSIBILITY OF A LICENSED ELECTRICAL CONTRACTOR. THE INSTALLATION SHALL BE IN ACCORDANCE WITH THE NATIONAL ELECTRICAL CODE AND ANY LOCAL CODES OR ORDINANCES THAT APPLY. IT SHALL BE THE ELECTRICAL CONTRACTOR'S RESPONSIBILITY TO COORDINATE THE POWER SOURCE AND EXACT LOCATION OF THE CONTROLLER WITH OWNER'S REPRESENTATIVE. FINAL CONNECTION OF THE VALVE WIRES TO THE CONTROLLER SHALL BE THE LANDSCAPE CONTRACTOR'S RESPONSIBILITY.

IT. INSTALL REMOTE CONTROL VALVES, PRESSURE REGULATOR AND QUICK COUPLER VALVES AS DETAILED. INSTALL R.C.Y. ID TAGS MANUFACTURED BY T. CHRISTY, ENT. STANDARD SIZE, I 1/8" HOT STAMPED BLACK LETTERS ON YELLOW BACKGROUND ON SOLENOID WIRES. LETTERS TO CONFORM TO CONTROLLER/STATION NUMBER.

18. ALL VALVE WIRING SHALL BE PAIGE 2 WIRE MAXI-CABLE. APPROVED FOR DIRECT BURIAL IN GROUND. CONNECT WIRES AS DETAILED PER MANUFACTURERS SPECIFICATIONS UTILIZING RAINBIRD DB GREASE FILLED CONNECTORS. ALL WIRE STRIPPING TO BE DONE WITH KING UF WIRE STRIPPER AVAILABLE ON AMAZON.COM. EACH WIRE AT VALVES SHALL HAVE 24" EXCESS COILED LOOP IN VALVE BOX. TAPE WIRE CABLE TO MAINLINE EVERY FIFTEEN FEET (15'). FLOW SENSOR WIRE SHALL BE PAIGE PESS FROM THE FLOW SENSOR TO THE 2 WIRE CABLE. PROVIDE 2 WIRE CABLE GROUND ROD IN BOX WITH RAINBIRD LSPI SURGE PROTECTOR EVERY 500' LF OR EVERY EIGHT DECODERS WHICH EVER COMES FIRST. 2 WIRE CABLE IS TO BE LOOPED AROUND THE BUILDING FROM THE CONTROLLER TO THE CONTROLLER. TAPE WIRE CABLE MAINLINE PER DETAILS.

19. ALL BACKFILL MATERIAL, OTHER THAN SAND AROUND THE MAINLINE, SHALL BE FREE OF ROCKS, CLODS AND OTHER EXTRANEOUS MATERIALS, COMPACT BACKFILL TO ORIGINAL DENSITY.

20. AT JOB COMPLETION, SUPPLY OWNER WITH ONE (2) SETS OF MATCHING QUICK COUPLER VALVE KEY AND HOSE SWIVEL, AND TWO (2) KEYS FOR EACH CONTROLLER, ALL MANUFACTURERS INFORMATION.

21. ACCURATELY AND NEATLY MARK ALL FIELD CHANGES MADE DURING CONSTRUCTION ON A DAILY BASIS ON ONE PLAN SET. ALL DRAFTING TO BE DONE BY A COMPETENT DRAFTSMAN. SUBMIT TO OWNER FOR RECORD. DIMENSION MAINLINE OFF BACK OF CURB OR SIDE WALK FOR REFERENCE ON CONSTRUCTION PLAN SET. LOCATE ALL RAIN SENSORS ON THE

PLAN.

22. ALL IRRIGATION INSTALLATION AND EQUIPMENT SHALL GUARANTEED FOR A PERIOD OF ONE YEAR.

23. REUSE OR RECYCLE EXCESS CONSTRUCTION MATERIAL.

24.PROVIDE I DIGITAL COPY OF SUBMITTAL PACKAGE OF ALL IRRIGATION COMPONENTS AND MATERIALS FOR APPROVAL BY LANDSCAPE ARCHITECT PRIOR TO COMMENCING WORK.

25.THE IRRIGATION CONTRACTOR SHALL FIELD VERIFY PRESSURE AT EACH POINT OF CONNECTION. THE SYSTEM IS DESIGNED WITH A MINIMUM OF 80 PSI AT

MAINTENANCE
THE IPPIGATION SHALL BE MA

THE METER POINT OF CONNECTION.

THE IRRIGATION SHALL BE MAINTAINED TO ENSURE SUFFICIENT AND TIMELY WATERING NECESSARY FOR THE SURVIVAL OF ALL PLANT MATERIAL. A COPY OF THE APPROVED IRRIGATION PLAN WITH ANY ASBUILT CONDITIONS, SHALL BE KEPT ON THE PROJECT SITE FOR REFERENCE. THE SYSTEM SHALL BE CHECKED YEARLY FOR CONTINUED OPERATION WITH THE ORIGINAL PLAN AND COMPONENTS ADJUSTED AND OR REPLACED AS REQUIRED FOR EFFICIENT OPERATION OF THE SYSTEM TO PROVIDE SUFFICIENT WATER TO ENSURE THE HEALTH OF THE PLANT MATERIAL.

LATERAL PIPE SIZING:
THE IRRIGATION CONTRACTOR SHALL INSTALL
BUBBLER AND OR SPRAY LATERAL SIZED AS

FOLLOWS:
System Design BUBBLERS ARE .25 GPM EACH:
ROTOR HEADS GPM PER LEGEND SHEET 2.1.
The system shall not exceed the following flow rates
for noted pipe sizes:

3/4", 4.0 GPM: 1", 12.0 GPM: 1 1/4", 22.0 GPM: 1 1/2", 30.0 GPM: 2", 50.0 GPM: 2 1/2", 75.0 GPM. HPA architecture

HPA, Inc.
383 4th Street, Suite 101
Oakland, CA
94607
tel: 949 •863 •1770
fax: 949 • 863 • 0851
email: hpa@hparchs.com

Landscape Architects, Inc. 1464 Popinjay Drive Reno, NV. p: 775 829 1364 email: bhatch00@charter.net







3353 Gateway Blvd. Fremont, CA 94538 tel: (510) 656-1900



International Park of Commerce IPC 3 Tenant Improvement

Tracy, CA



CIVIL Kier & Wright
STRUCTURAL
MECHANICAL
PLUMBING
ELECTRICAL
LANDSCAPE Green Design

FIRE PROTECTION

SOILS ENGINEER

Title:

PLAN BUILDING 3

Project Number: 22608

Drawn by: BH

Date: 09/30/22

Revision:

Sheet:

L2.2



CITY OF TRACY

DETERMINATION OF THE DEVELOPMENT SERVICES DIRECTOR

Application Number D22-0049

A determination of the Development Services Director approving Development Review Permit Application Number D20-0049 for 107 additional automobile parking spaces at an existing light industrial development at 6551 West Schulte Road, Assessor's Parcel Number 209-120-09 - Applicant is HPA, Inc. and Owner is Prologis. L.P.

Staff has reviewed the application and determined that the following City regulations apply:

- 1. Cordes Ranch Specific Plan
- 2. Existing improvements approved under Development Review Permit Application D16-0011
- 3. Parking, circulation, and landscaping

The Development Services Director has determined that the proposed project is consistent with the Cordes Ranch Specific Plan Environmental Impact Report (EIR), approved by the City Council on September 3, 2013, and the General Plan EIR approved by the City Council on February 1, 2011. Pursuant to CEQA Guidelines Section 15183, no additional environmental documentation is required. The project will not introduce significant on or off-site impacts which were not already discussed in the Cordes Ranch and General Plan EIRs. There is also no evidence of any significant impacts to occur off-site as a result of the project, as traffic, air quality, land use and other potential cumulative impacts have already been considered within the original environmental documentation. No new evidence of potentially significant effects has been identified as a result of this project.

THE DEVELOPMENT SERVICES DIRECTOR, AFTER CONSIDERING ALL OF THE EVIDENCE PRESENTED, HEREBY APPROVES DEVELOPMENT REVIEW PERMIT FOR THE ADDITIONAL AND MODIFIED TRAILER PARKING AND ASSOCIATED SITE IMPROVEMENTS AT PROJECT BIG BIRD, APPLICATION NUMBER D22-0049, SUBJECT TO THE CONDITIONS CONTAINED IN EXHIBIT 1 AND BASED ON THE FOLLOWING FINDING:

- 1) The proposal increases the quality of the project site, and enhances the property in a manner that therefore improves the property in relation to the surrounding area and the citizens of Tracy, because the proposed project would be constructed to match the existing site and landscaping design in a manner that is consistent with the Cordes Ranch Areas Specific Plan. The parking areas will be accessible by existing drive aisles that already provide through-circulation throughout the site. New landscaping, including canopy shade trees, will be provided for the additional parking areas with a palette that complements the existing landscaping.
- The proposal conforms to the City of Tracy General Plan, the Cordes Ranch Specific Plan, the City's Design Goals and Standards, any applicable Infrastructure Master Plans, City Standard Plans, and other City regulations.

Jaylen French	Date of Action
Development Services Director	

CITY OF TRACY CONDITIONS OF APPROVAL

IPC 3 Additional Automobile Parking Application Number D22-0049

A. General Provisions and Definitions

- 1. These Conditions of Approval shall apply to the real property located at 6551 West Schulte Road, Assessor's Parcel Number 209-120-09, Application Number D22-0049, for 107 additional automobile parking spaces at the IPC Building 3 site (hereinafter "Project").
- 2. The following definitions shall apply to these Conditions of Approval:
 - a. "Applicant" means any person, or other legal entity, defined as a "Developer".
 - b. "City Engineer" means the City Engineer of the City of Tracy, or any other duly licensed engineer designated by the City Manager, or the Development Services Director, or the City Engineer to perform the duties set forth herein.
 - c. "City Regulations" means all written laws, rules, and policies established by the City, including those set forth in the City of Tracy General Plan, the Tracy Municipal Code, Cordes Ranch Specific Plan, ordinances, resolutions, policies, procedures, and City's Design Documents (including the Standard Plans, Standard Specifications, Design Standards, and relevant Public Facility Master Plans), and the California Building Code and California Fire Code.
 - d. "Development Services Director" means the Development Services Director of the City of Tracy, or any other person designated by the City Manager or the Development Services Director to perform the duties set forth herein.
 - e. "Conditions of Approval" shall mean the conditions of approval applicable to the 107 additional automobile parking spaces at the IPC Building 3 site, Application Number D22-0049. The Conditions of Approval shall specifically include all City of Tracy conditions set forth herein, including South San Joaquin County Fire Authority conditions, set forth herein.
 - f. "Project" means Application Number D22-0049 consisting of 107 additional automobile parking spaces at the IPC Building 3 site located at 6551 West Schulte Road, Assessor's Parcel Number 209-120-09.
 - g. "Developer" means any person, or other legal entity, who applies to the City to divide or cause to be divided real property within the Project boundaries, or who applies to the City to develop or improve any portion of the real property within the Project boundaries. The term "Developer" shall include all successors in interest.
- 3. The Developer shall comply with all laws (federal, state, and local) related to the development of real property within the Project, including, but not limited to: the

Planning and Zoning Law (Government Code sections 65000, et seq.), the Subdivision Map Act (Government Code sections 66410, et seq.), the California Environmental Quality Act (Public Resources Code sections 21000, et seq., "CEQA"), and the Guidelines for California Environmental Quality Act (California Administrative Code, Title 14, Sections 1500, et seq., "CEQA Guidelines").

- 4. Unless specifically modified by these Conditions of Approval, the Developer shall comply with all City Regulations.
- 5. Pursuant to Government Code section 66020, including section 66020(d)(1), the City HEREBY NOTIFIES the Developer that the 90-day approval period (in which the Developer may protest the imposition of any fees, dedications, reservations, or other exactions imposed on this Project by these Conditions of Approval) has begun on the date of the conditional approval of this Project. If the Developer fails to file a protest within this 90-day period, complying with all of the requirements of Government Code section 66020, the Developer will be legally barred from later challenging any such fees, dedications, reservations or other exactions.

B. Planning Division Conditions of Approval

- B.1. Except as otherwise modified herein, the project shall be developed in accordance with the plans received by the Development Services Department on December 29, 2022. Prior to the issuance of any building permits, any deviations from the approved plans shall be evaluated for substantial compliance with the approved plans to the satisfaction of the Development Services Director. Should any deviations be determined not to be in substantial compliance with the approved plans, they shall be reviewed in a new Development Review application process.
- B.2. The applicant shall pay all applicable fees for the project, including, but not limited to, development impact fees, building permit fees, plan check fees, grading permit fees, encroachment permit fees, inspection fees, school fees, or any other City or other agency fees or deposits that may be applicable to the project.
- B.3. All improvements shall be consistent with the Tracy Municipal Code, Cordes Ranch Specific Plan, Standard Plans, and other applicable City Regulations.
- B.4. Before the approval of a building permit, the applicant shall provide detailed plans that demonstrate a minimum of one foot candle throughout the parking areas. All exterior lighting shall be directed downward, onto the parking and maneuvering surface and away from the public rights-of-way.
- B.5. Prior to the erection of any light poles with a height in excess of 40 feet, the developer shall gain the approval of the Conditional Use Permit from the Planning Commission. Should a Conditional Use Permit not be approved, any freestanding light poles shall not exceed a height of 40 feet.
- B.6. Prior to issuance of a building permit, detailed plans demonstrating compliance with onsite landscaping standards as established in the Cordes Ranch Specific Plan and

the Tracy Municipal Code Off-Street Parking ordinance. Such plans shall demonstrate that all landscape areas, including bioswales, are appropriately comprised of a combination of trees, shrubs, groundcover, and irrigation to the satisfaction of the Development Services Director.

- B.7. Where landscape planters are parallel and adjacent to the side of vehicular parking spaces, a 12" wide concrete curb shall be placed adjacent to the parking space to allow for pedestrian access to vehicles without damage to the landscape areas.
- B.8. Prior to issuance of a building permit, an Agreement for Maintenance of Landscape and Irrigation Improvements shall be executed and financial security submitted to the Development Services Department. The Agreement shall ensure maintenance of the on-site landscape and irrigation improvements for a period of two years. Said security shall be equal to the actual material and labor costs for installation of the on-site landscape and irrigation improvements or \$2.50 per square foot of on-site landscape area.
- B.9. Prior to final inspection or certificate of occupancy, all landscaping and irrigation substantially conforming with the development review permit plans dated December 29, 2022 and the approved building permit construction plans shall be installed to the satisfaction of the Development Services Director.
- B.10. Unless specifically modified by these Conditions of Approval, the Developer shall comply with all mitigation measures identified in the Cordes Ranch Specific Plan Environmental Impact Report (EIR), approved by the City Council on September 3, 2013, and the General Plan EIR approved by the City Council on February 1, 2011.

C. Engineering Division Conditions of Approval

C.1. General Conditions

- C.1.1 Developer shall comply with the applicable requirements of the technical analyses and reports prepared for the Project listed as follows:
 - a) "Mitigation Measures and Monitoring Program for the Cordes Ranch Specific Plan", adopted by the City Council September 3, 2013 (Resolution No. 2013-143).
 - b) "Geotechnical Investigation for IPC Building 3 & 4 Prologis" titled International Park of Commerce (IPC) Buildings 3,4, and Associated Detention Basins North of Gateway Boulevard and Old Schulte Road Intersection, Tracy, California" prepared by Kleinfelder, dated May 12, 2016, and any subsequent amendments or updates.
- C.1.2 Developer shall comply with applicable requirements of the Development Agreement By and Between the City of Tracy and Prologis, L.P., approved by City Council September 3, 2013 (Ordinance Number 1188).

C.2. Grading Permit

The City will not accept grading permit application for the Project as complete until the Developer has provided all relevant documents related to said grading permit required

by the applicable City Regulations and these Conditions of Approval, to the satisfaction of the City Engineer, including, but not limited to, the following:

- C.2.1. Grading and Drainage Plans prepared on a 24" x 36" size paper. Grading and Drainage Plans shall be prepared under the supervision of and stamped and signed by a Registered Civil Engineer.
- C.2.2. Payment of the applicable Grading Permit fees which include grading plan checking and inspection fees, and other applicable fees as required by these Conditions of Approval.
- C.2.3. For Projects on property smaller than one (1) acre: Prior to the issuance of the Grading Permit, the Developer shall submit to the Utilities Department (stephanie.hiestand@cityoftracy.org) one (1) electronic copy and 1 hard copy of the City of Tracy Erosion and Sediment Control Plan (ESCP) for approval. Cost of preparing the ESCP including any annual storm drainage fees shall be paid by the Developer. Developer shall comply with all the requirements of the ESCP, applicable BMPs and the Post-Construction Stormwater Standards adopted by the City in 2015 and any subsequent amendment(s).
- C.2.4. Developer shall provide a PDF copy of the Project's Geotechnical Report signed and stamped by a Registered Geotechnical Engineer. The technical report must include relevant information related to soil types and characteristics, soil bearing capacity, compaction recommendations, retaining wall recommendations, if necessary, paving recommendations, paving calculations such as gravel factors, gravel equivalence, etc., slope recommendations, and elevation of the highest observed groundwater level.
- C.2.5. A copy of the Approved Fugitive Dust and Emissions Control Plan that meets San Joaquin Valley Air Pollution Control District (SJVAPCD) as required in Mitigation Measure AQ-1 and AQ-2 of the Mitigation Monitoring and Reporting Program of the Cordes Ranch Specific Plan Final Environmental Impact Report (CRSP EIR).
- C.2.6. Documentation of any necessary authorizations from Regional Water Quality Control Board (RWQCB) as required in the applicable mitigation measures identified in the Cordes Ranch Specific Plan EIR.
- C.2.7. Two (2) sets of Hydrologic and Storm Drainage Calculations for the design of the on-site storm drainage system, as required in Conditions C.3.2.a, below.

C.3. Grading and Storm Drainage Plans

C.3.1. Site Grading

- a) Include all proposed erosion control methods and construction details to be employed and specify materials to be used. All grading work shall be performed and completed in accordance with the recommendation(s) of the Project's Geotechnical Engineer. A copy of the Project's Geotechnical Report must be submitted with the Grading and Storm Drainage Plans.
- a) When the grade differential between the Project Site and adjacent property(s) exceeds 12 inches, a reinforced concrete or masonry block, or engineered retaining wall is required for retaining soil. The Grading Plan

- shall show construction detail(s) of the retaining wall or masonry wall. The entire retaining wall and footing shall be constructed within the Project Site. A structural calculation shall be submitted with the Grading and Storm Drainage Plans.
- a) An engineered fill may be accepted as a substitute of a retaining wall, if any, subject to approval by the City Engineer. The Grading and Storm Drainage Plans must show the extent of the slope easement(s). The Developer shall be responsible for obtaining permission from owner(s) of the adjacent and affected property(s). The slope easement must be recorded, prior to the issuance of the final building certificate of occupancy.
- a) Grading for the site shall be designed such that the Project's storm water can overland release to either a public street or to a public storm drainage facility.

C.3.2. Storm Drainage

- a. Calculations related to the design and sizing of on-site storm water treatment facilities must be submitted with the Grading and Storm Drainage Plans, and approved by City's Stormwater Coordinator prior to issuance of the Grading Permit for the Project.
- b. The design and construction details of the Project's storm drainage system and treatment facilities shall meet City Regulations and shall comply with the applicable requirements of the Multi-Agency Post-Construction Stormwater Standards Manual, dated June 2015 and any subsequent amendments.

D. Building Safety Division Conditions of Approval

- D.1. Prior to construction, applicant shall submit plans and details to the Building Safety Division that demonstrate compliance accessibility requirements for the increase in parking spaces available (i.e. parking analysis) to this facility per California Building Code 11B-208.
- D.2. At the time of improvement plan application, applicant to submit plans and/or details that demonstrate compliance with accessibility requirements including 2% maximum cross slopes where driveway serves as an accessible route per California Building Code 11B-206.
- D.3. At the time of improvement plan application, applicant to submit plans and/or details that demonstrate compliance with accessibility requirements at sidewalk joints including maximum opening and changes in level per California Building Code 11B-302.3 and 11B-303 respectively.

E. South San Joaquin County Fire Authority (SSJCFA) Conditions of Approval

- E.1. Prior to construction, applicant shall submit construction documents to the South San Joaquin County Fire Authority for review and approval.
 - E.1.1. Construction documents shall be designed to the current edition of the California Code of Regulations, Title 24, as amended by the City of Tracy Municipal Code.
 - E.1.2. Engineering and building permit applications received by our offices are subject to the current fee schedule for South San Joaquin County Fire Authority. Contact our offices for additional information.
- E.2. Fire apparatus access roads during construction shall have a minimum 26' unobstructed width in accordance with CFC §503.
- E.3. All exterior doors from the warehouse shall be maintained accessible during construction in compliance with Chapter 32 of the California Fire Code.